PROJECT TEAM

OWNER: THE CAREY SCHOOL

ONE CAREY SCHOOL LANE, SAN MATEO, CA 94403 (650) 345-8205

ARCHITECT: **HKIT ARCHITECTS**

538 9TH STREET, SUITE 240, OAKLAND, CA 94607 (510) 625-9800

ELECTRICAL BWF CONSULTING ENGINEERS

ENGINEER: 220 S. SPRUCE AVENUE, SUITE 203, SOUTH SAN FRANCISCO, CA 94080 (650) 871-0220

BELLECCI & ASSOCIATES, INC. CIVIL ENGINEER:

2290 DIAMOND BOULEVARD, SUITE 100, CONCORD CA 94520 (925) 283-4891

LANDSCAPE **KELLER MITCHELL & CO.**

ARCHITECT 302 FOURTH STREET, OAKLAND, CA 94607 (510) 451-9987

PROJECT DESCRIPTION

REMOVAL OF A 1-STORY PORTION OF THE EXISTING BUILDING WHICH INCLUDES 4-CLASSROOM AND SELECTIVE SITEWORK REMOVAL CONSTRUCTION OF A 2-STORY ADDITION TO THE EXISTING BUILDING WHICH INCLUDES 4 CLASSROOMS, SMALL MULTIUSE SPACE AND MEETING ROOMS

AND A COURTYARD REMODEL RELATED SITE AND UTILITY WORK IS ALSO INCLUDED.

REGULATORY REQUIREMENTS

PART 1: 2016 CALIFORNIA ADMINISTRATIVE CODE PART 2: 2016 CALIFORNIA BUILDING CODE (BASED ON THE 2015 INTERNATIONAL BUILDING CODE - IBC PART 3: 2016 ELECTRICAL CODE (BASED ON THE 2015 NATIONAL ELECTRICAL CODE - NEC

PART 7: (NO LONGER PUBLISHED IN TITLE 24. SEE TITLE 8, CCR)

C. SAN MATEO COUNTY CODES AND REGULATIONS (WHERE APPLY)

PARKING SUMMARY - CARS

47 CURRENT EMPLOYEES + 5 NEW EMPLOYEES = 52 PARKING SPACES MINIMUM REQUIRED

ON-SITE PARKING SUMMARY (NO CHANGES OFF-SITE PARKING (NO CHANGES FROM

FROM EXISTING) (E) STANDARD SPACES

(E) COMPACT SPACES (E) ACCESSIBLE SPACE

27 (E) TOTAL ON-SITE PARKING SPACES

30 (E) PARKING SPACES FOR STAFF AT 1900-2000 ALAMEDA DE LAS PULGAS

PARKING SUMMARY - BIKES

15 EXISTING SPACES PROVIDED

1 PARKING SPACE PER EMPLOYEE

30 PARKING SPACES FOR STAFF AT

1900-2000 ALAMEDA DE LAS PULGAS PARKING SPACES FOR EVENTS 1900-2000 ALAMEDA DE LAS PULGAS

= 57 EXISTING PARKING SPACES PROVIDED


258 STUDENTS / 20 = 13 SPACES REQUIRED

52 STAFF / 10 = 5 SPACES REQUIRED

5 EXISTING WALL MOUNTED SPACES PROVIDED AT THE LOWER LEVEL IN STORAGE ROOM A007

Junipero Serra High School Maxim Healthcare Services 1 Carey School Lane Fusion Academy San Mateo AREA OF OFF-SITE PARKING 1900-2000 ALAMEDA DE LAS PULGAS **VICINITY MAP** 2103 ALAMEDA DEL LAS PULGAS

CODE AND AREA ANALYSIS

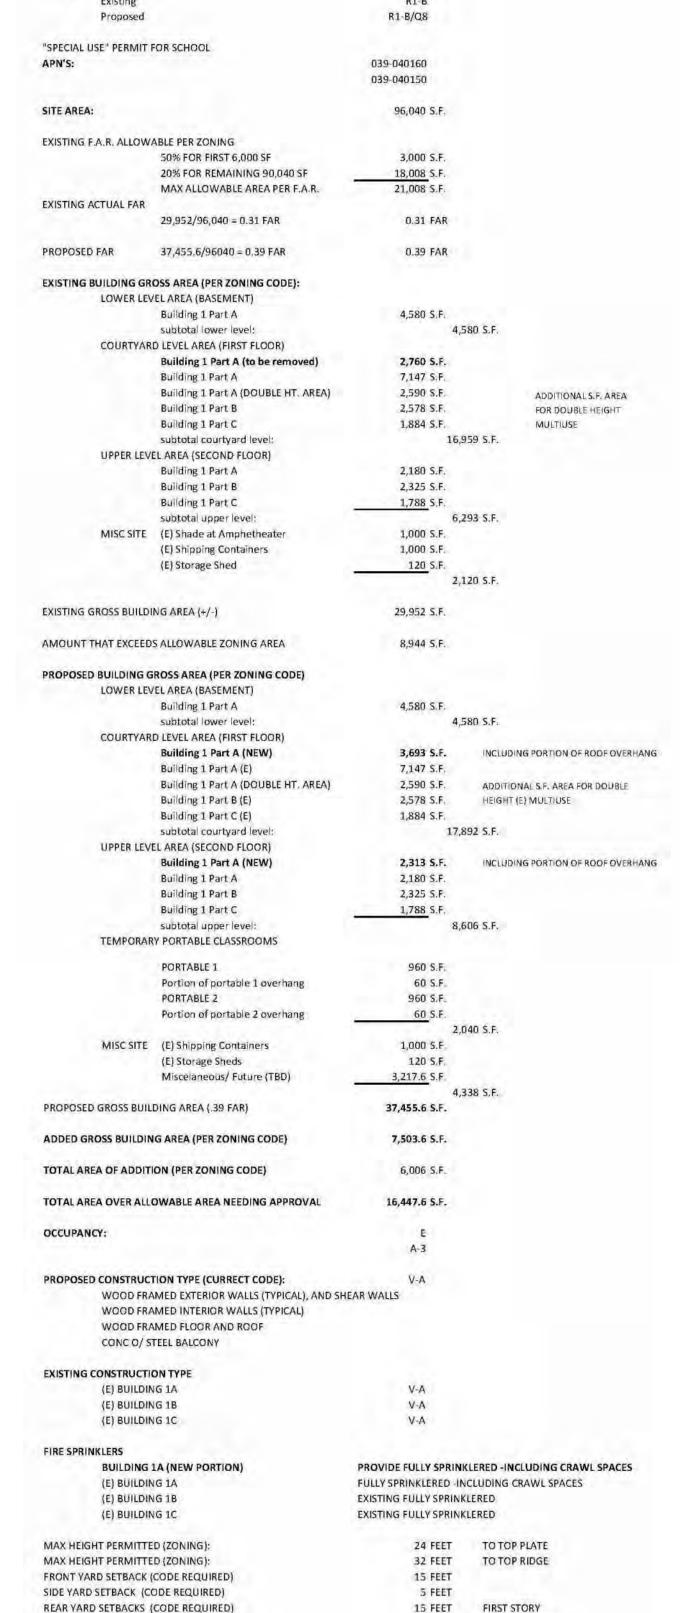


SECOND STORY

25 FEET

300 CU YD

CUBIC YARDS OF SOIL DISTURBANCE:

SHEET INDEX

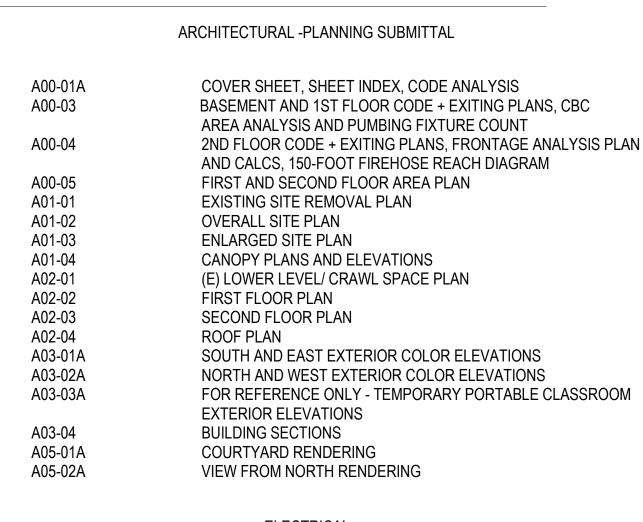

E01-01 E01-02 E03-02 E03-03	ELECTRICAL LEGEND, FIXTURE SCHEDULE AND DETAILS ELECTRICAL SITE PLAN AND PHOTOMETRIC STUDY ELECTRICAL FIRST FLOOR LIGHTING ELECTRICAL SECOND FLOOR LIGHTING
E1.0B	EXISTING 2013 ELECTRICAL PHOTMETRIC PLAN - FOR REFERENCE ONLY

CIVIL SURVEY

TOPOGRAPHIC SURVEY


CIVIL

1.1	DEMOLITION PLAN
2.1	GRADING PLAN
3.1	UTILITY PLAN
4.1	IMPERVIOUS AREA PLAN

LANDSCAPE

L00.01	OVERALL LANDSCAPE SITE PLAN
L01.01	PROPOSED LANDSCAPE SITE PLAN
L02.01	PROPOSED PLANTING PLAN

PROPOSED LANDSCAPE MATERIALS IMAGES

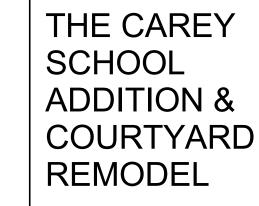

2103 ALAMEDA DE LAS PULGAS SAN MATEO, CA 94403 JOB NO.

ASM/ JAS CHECKED

DRAWN

JOB CAPTAIN JAS ISSUE DATE DESCRIPTION 100% SD/ PLANNING

2018	SUBMITTAL
JAN. 30, 2019	PLANNING RESUBMITTAL
FEB. 6, 2019	PLANNING RESUBMITTAL R2

DRAWING TITLE

COVER SHEET SHEET INDEX, CODE **ANALYSIS**



SHEET NOTES - CODE AND EXITING PLANS PORTION OF BUILDING IS ONE STORY ABOVE GRADE PLANE

- A. ALL AREAS OF THE SCHOOL ARE "E" OCUPANCY EXCEPT THE MULTI-USE SPACES AND RELATED STORAGE WHERE INDICATED ON THE PLANS.
- SEE SITE PLAN SHEETS A01-01 AND A01-02 FOR ADDITIONAL SITE
- SEE COVER SHEET FOR GOVERNING CODES
- SECOND FL. AREA IS LESS THAN 3000 S.F. LIFT IS NOT REQUIRED PER

- PORTION OF BUILDING IS TWO STORIES ABOVE GRADE PLANE
- PORTION OF BUILDING (BASEMENT) IS A STORY BELOW GRADE PLANE
 - PORTION OF BUILDING IS AN EXISTING TWO STORY-BUILDING ABOVE GRADE PLANE
 - A3 OCCUPANCY (SHOWN TONED)
 - ACCESSIBLE PATH OF TRAVEL (E) WHEELCHAIR LIFT
 - CRAWL SPACE ACCESS HATCHES
 - CEILING IS AT 15'-0" ABOVE FIRST FLOOR (AREA ONLY COUNTED ONCE)
 - OCCUPANT LOAD IS LESS THAN 49 PER TABLE 1006.2.1 ONLY ONE EXIT DOOR IS REQUIRED BALCONY AND 2 STAIRS (2 EXITS) MEETS REQUIREMENT OF CBC 452.1.4 EXCEPTION 2
 - EXIT STAIR 44" WIDE. MAX STAIR RISE 12'-0" WITHOUT AN INTERMEDIATE LANDING
 - **EXISTING EGRESS BALCONY**
 - EGRESS BALCONY EGRESS RAMP
 - (E) FIRELANE AT LEVEL BELOW
 - (E) FIRELANE
 - (E) FIRELANE ACCESS POINT FOR REFERENCED LEVEL

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PLUMBING FIXTURE COUNT

Carey	School	WC	wc	Urinal	Drinking Fountain	wc	WC	Urinal	Drinking Fountain
		Male	Female			Male	Female		
		1 per 50	1 per 30	1 per 100	1 per 150	1 per 50	1 per 30	1 per 100	1 per 150
	load factor 60								
271	Students				2				2
135.5	Male	3		2		4		2	
135.5	Female		5				6		
33	Staff			1	1				1
16.5	Male	1				2		1	4
16.5	Female		1				2		
			REQU	JIRED			PRO\	/IDED	

THE CAREY **SCHOOL ADDITION &** COURTYARD REMODEL

2103 ALAMEDA DE LAS PULGAS

10232

JAS/ ASM

SAN MATEO, CA 94403

JOB NO.

CBC Allowable Area Analysis

Proposed Addition Construction Type

Existing Building Construction Type Fully Sprinklered

Table 504.3 Allowable Building Height

> 70 feet (S without Area increase)

Zoning more restrictive

Fully Sprinklered

Table 504.4 Allowable number of Stories 3 stories (without Area increase)

(Actual number of stories) 2 stories

Table 506.2 Allowable Area Factor

> A3 = SM34,500 S.F. (without Height Increase) 55,500 S.F. E = SM(without Height Increase)

Use A3 34,500 S.F. Most Restrictive per 508.3.1

MIXED OCCUPANCY, MULTISTOREY

[A1 + (NS X If)]

34,500 11,500

0.53 (From Frontage Analysis on sheet A00-04)

34,500 + (11,500 X 0.53)

506.2.4

"aggregate sum of the ratios of the actual building area divided by the

40,595 S.F. PER STORY

allowable area of such stories"

First Floor (LARGEST FLOOR)

(E = 10,544)(A3 = 7332) PLUS 40,595 40,595

> 0.18 PLUS 0.26 EQUALS 0.44 (LESS THAT 2 = OK)

Non separated occupancies


A,E to A,E S / N No separation regirement

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DRAWING TITLE

BASEMENT AND 1ST FLOOR CODE AND EXITING PLANS, CBC AREA ANALYSIS AND PLUMBING FIXTURE COUNT

SCALE As indicated

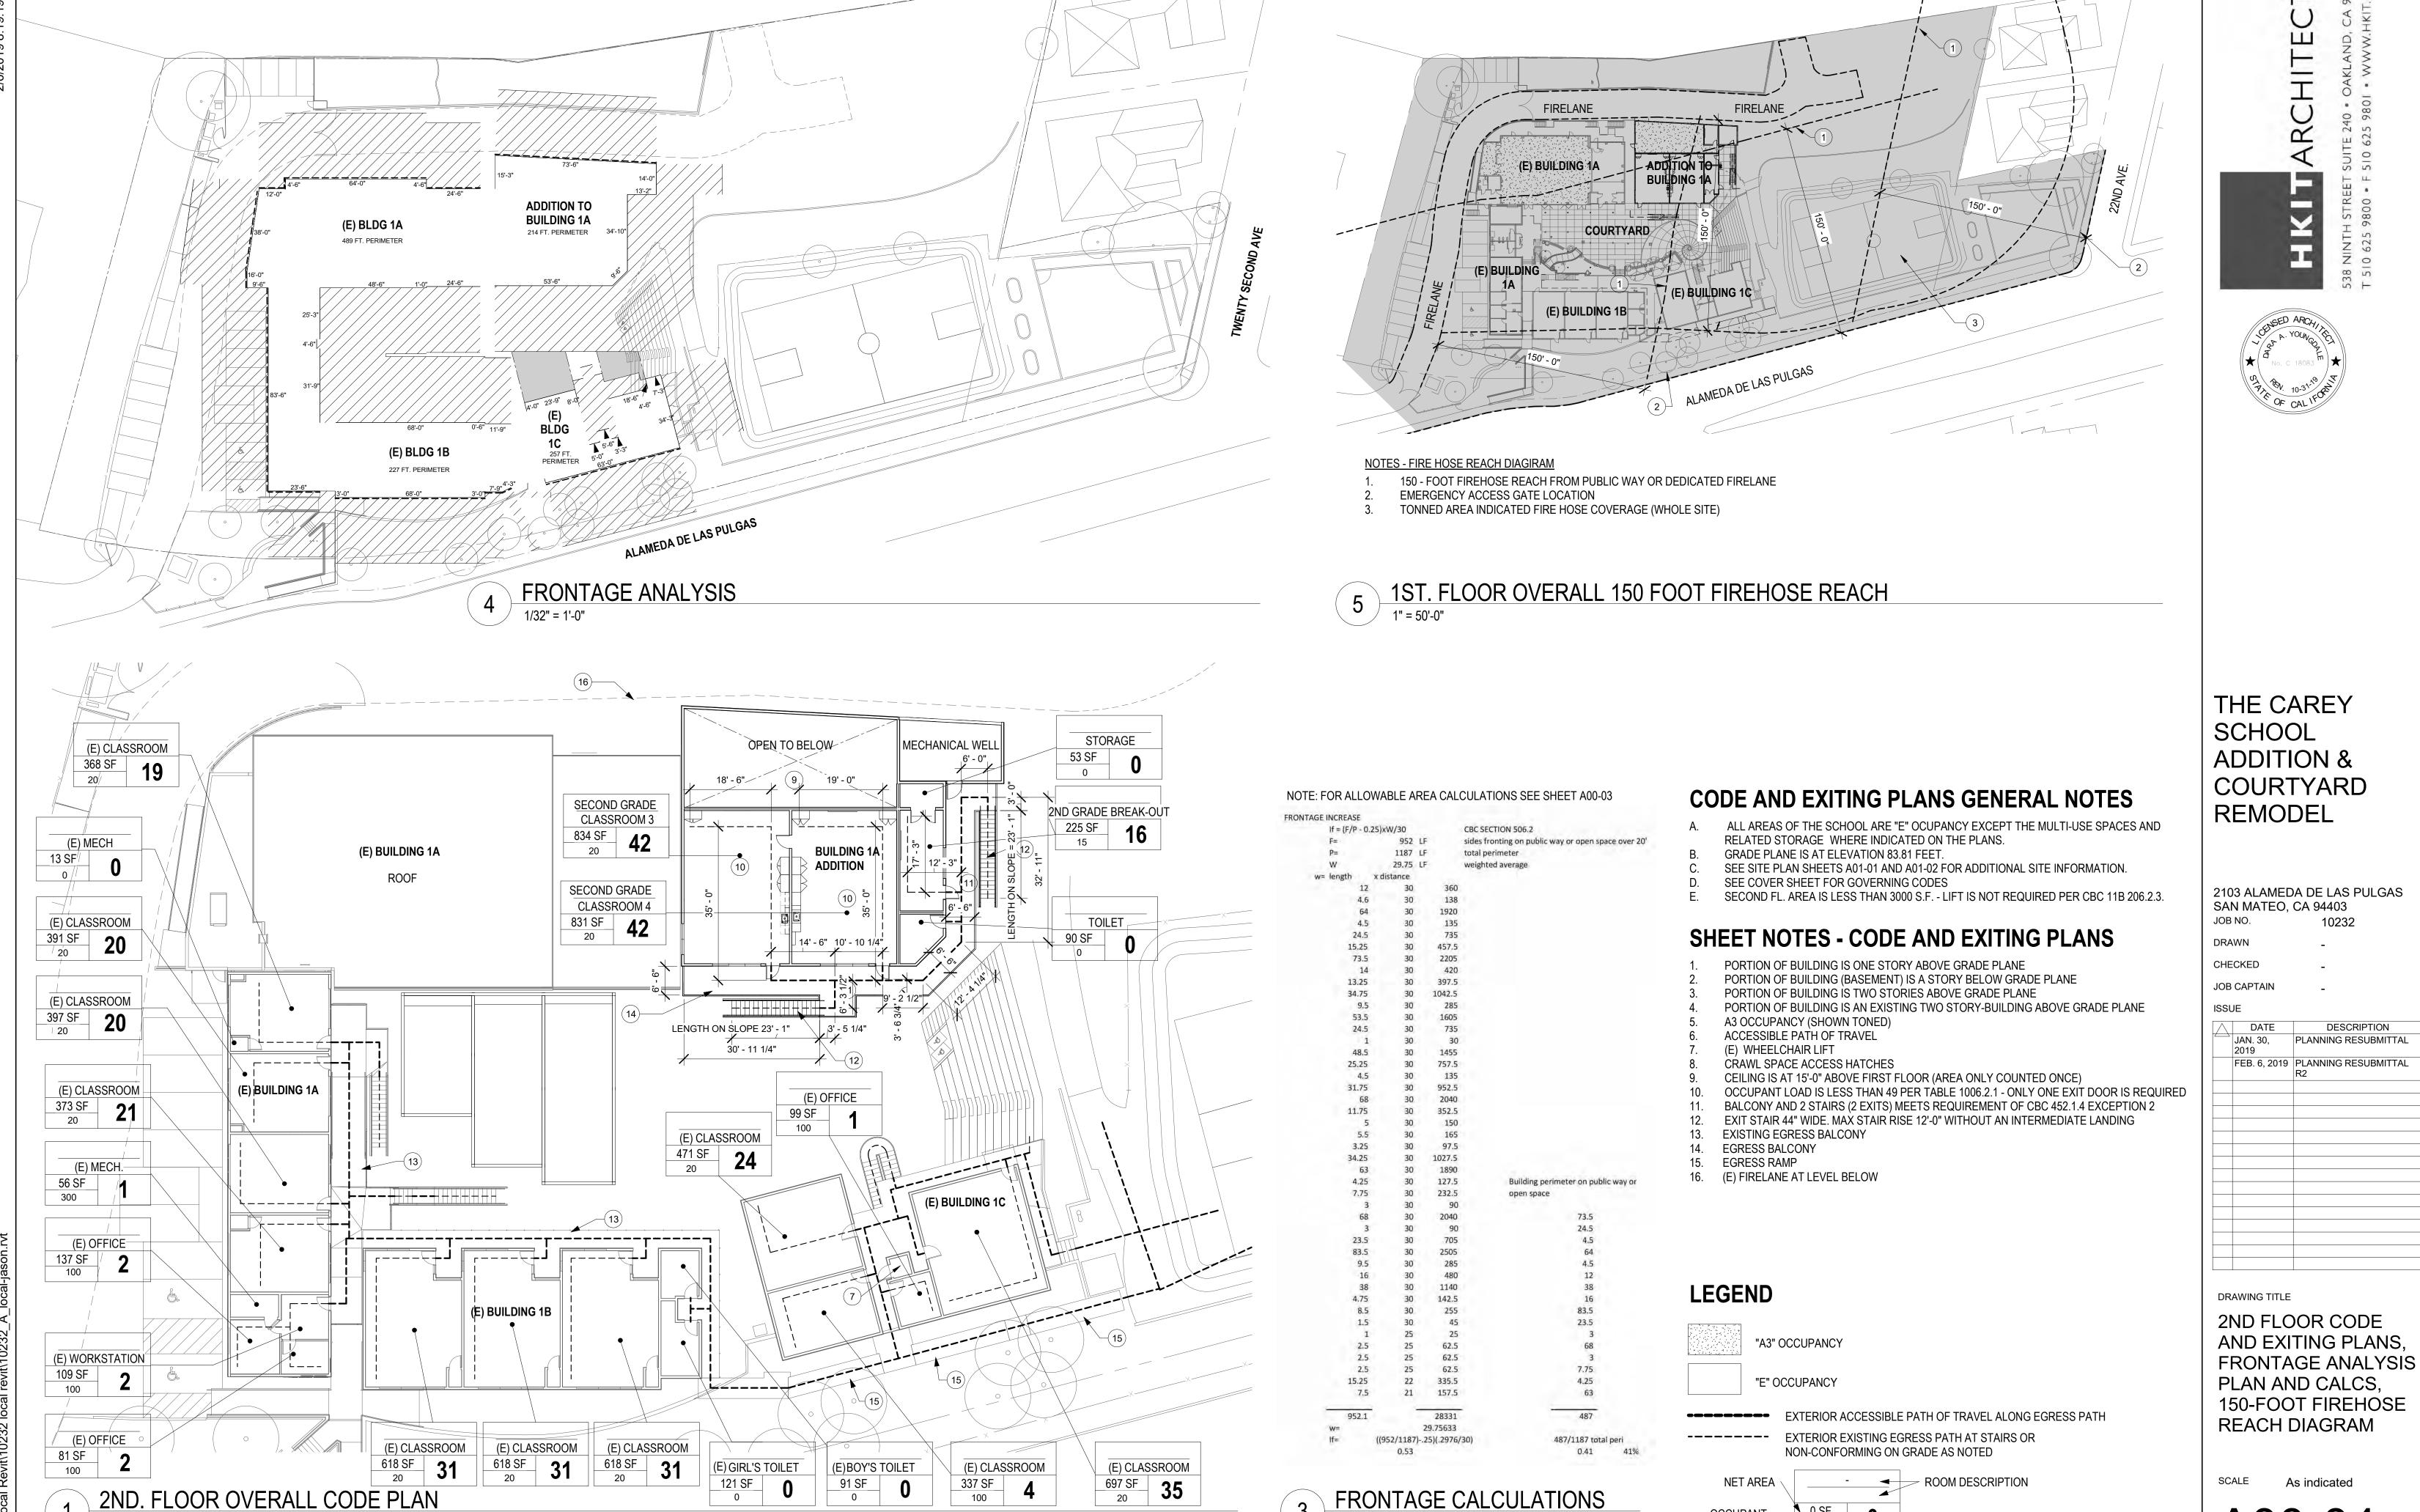

1/16" = 1'-0"

1/32" = 1'-0"

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OCCUPANT

LOAD FACTOR → 0

NUMBER OF OCCUPANTS



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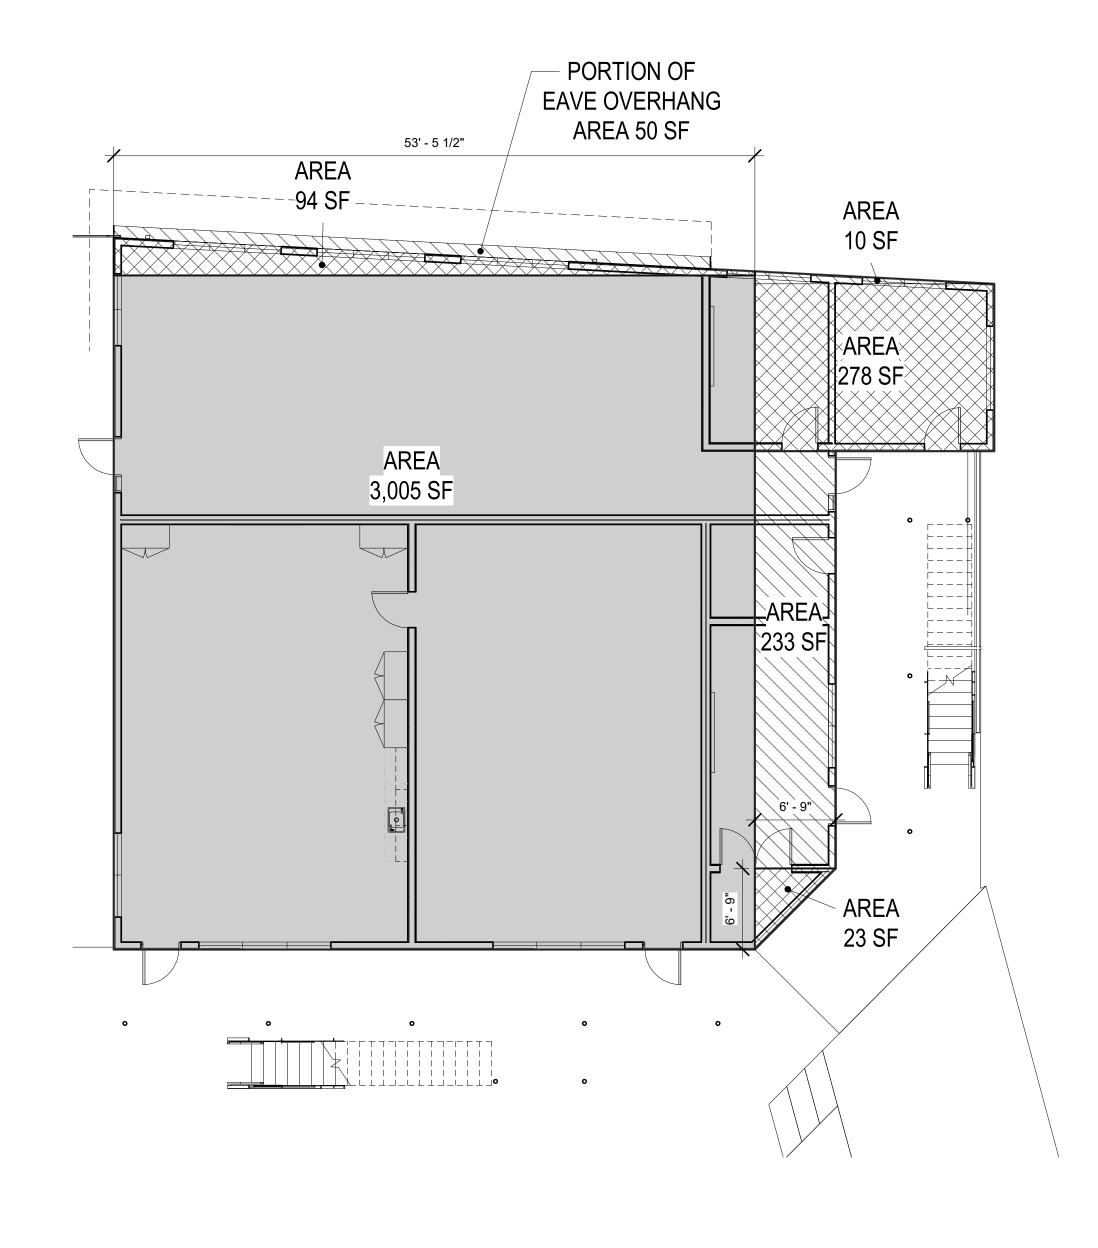
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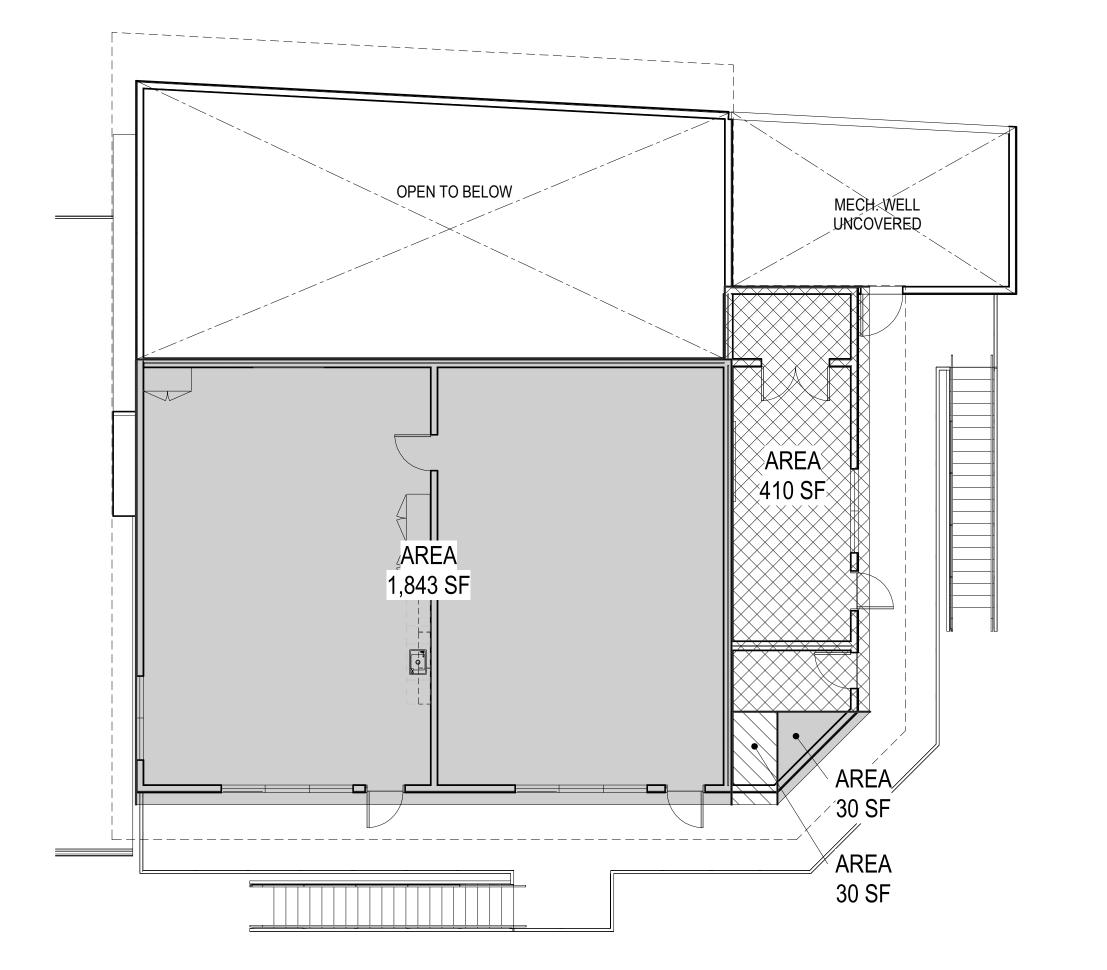
ISSUE

✓ DATE DESCRIPTION 100% SD/ PLANNING SUBMITTAL JAN. 30, 2019 PLANNING RESUBMITTAL FEB. 6, 2019 PLANNING RESUBMITTAL R2

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FIRST AND SECOND FLOOR AREA PLAN





1 FIRST FLOOR AREA PLAN
1/8" = 1'-0"

SECOND FLOOR AREA PLAN
1/8" = 1'-0"

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* No. C 18083 TH * No.

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ASM/ JAS

DESCRIPTION

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JOB CAPTAIN JAS

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NOV. 16, 2018 SUBMITTAL

JAN. 30, 2019


FEB. 6, 2019 PLANNING RESUBMITTAL R2

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EXISTING SITE REMOVAL PLAN

ALE As indicated

A01-01

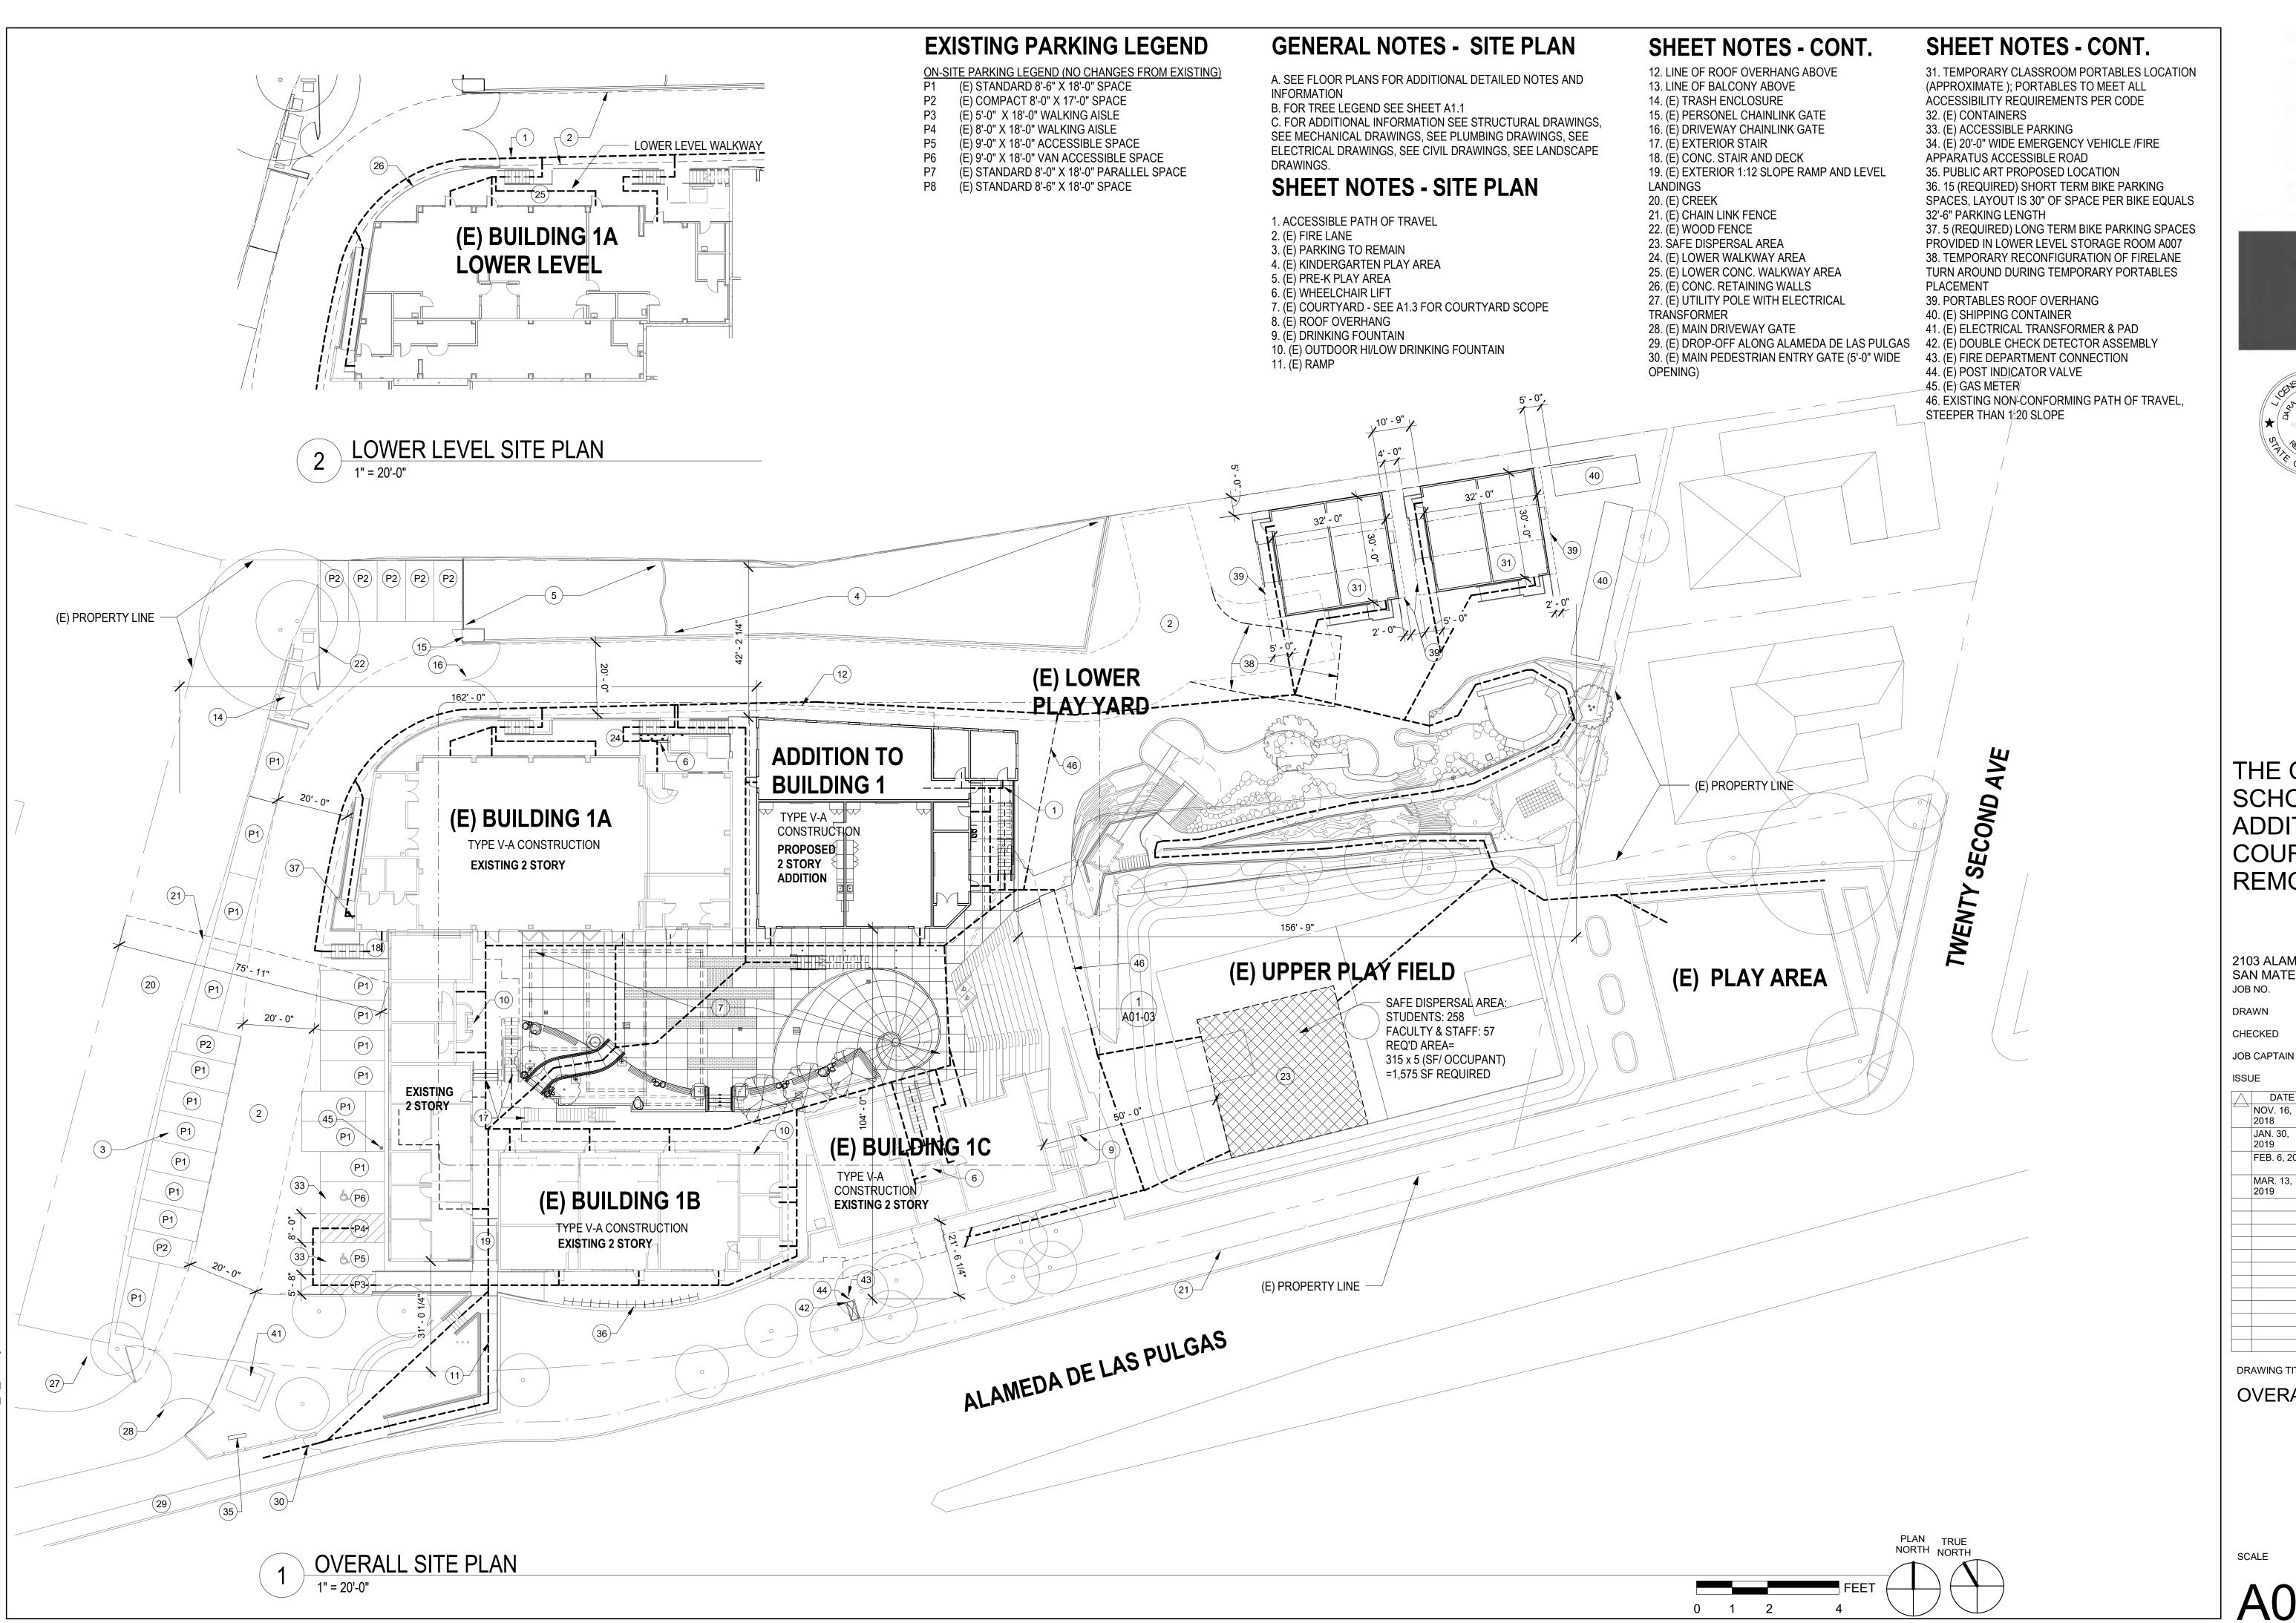

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JAS

JAS

1330E				
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	JAN. 30, 2019	PLANNING RESUBMITTAL		
	FEB. 6, 2019	PLANNING RESUBMITTAL R2		
	MAR. 13, 2019	PLANNING RESUBMITTAL R4		

DRAWING TITLE

OVERALL SITE PLAN

As indicated

GENERAL NOTES

A. PROJECT IS REQUIRED TO ACHIEVE " LEED CERTIFIED". B. SEE EXTERIOR ELEVATIONS FOR WINDOW NOTES

SHEET NOTES

- 1 CONCRETE PAVING
- 2 PERMEABLE PAVING
- 3 STEEL COLUMNS SUPPORTING SUNSHADE CANOPY ABOVE
- 4 SUNSHADE CANOPY ABOVE
- CONCRETE PAVING AND FIBONACCI SPIRAL W/ COLORED CONCRETE BAND AT COURTYARD
- 6 (E) COURTYARD TIERED SEATING TO REMAIN
- 7 8% SLOPE CONCRETE RAMP W/ HANDRAILS AND LEVEL LANDING AT TOP & BOTTOM
- 8 TREES & PLANTER BEDS W/ LOW RETAINING WALL
 9 (E) STAIR & GUARDRAIL
- (E) INCLINED STAIR LIFT TO LOWER YARD AND LOWER LEVEL
- (E) DRINKING FOUNTAIN
- (E) CONCRETE WALKWAY BETWEEN BUILDINGS
- 13 LOWER PLAY YARD
- 14 ACCESS TO UPPER PLAYGROUND
- 15 ASPHALT WALKWAY
- 16 LANDSCAPE AREA

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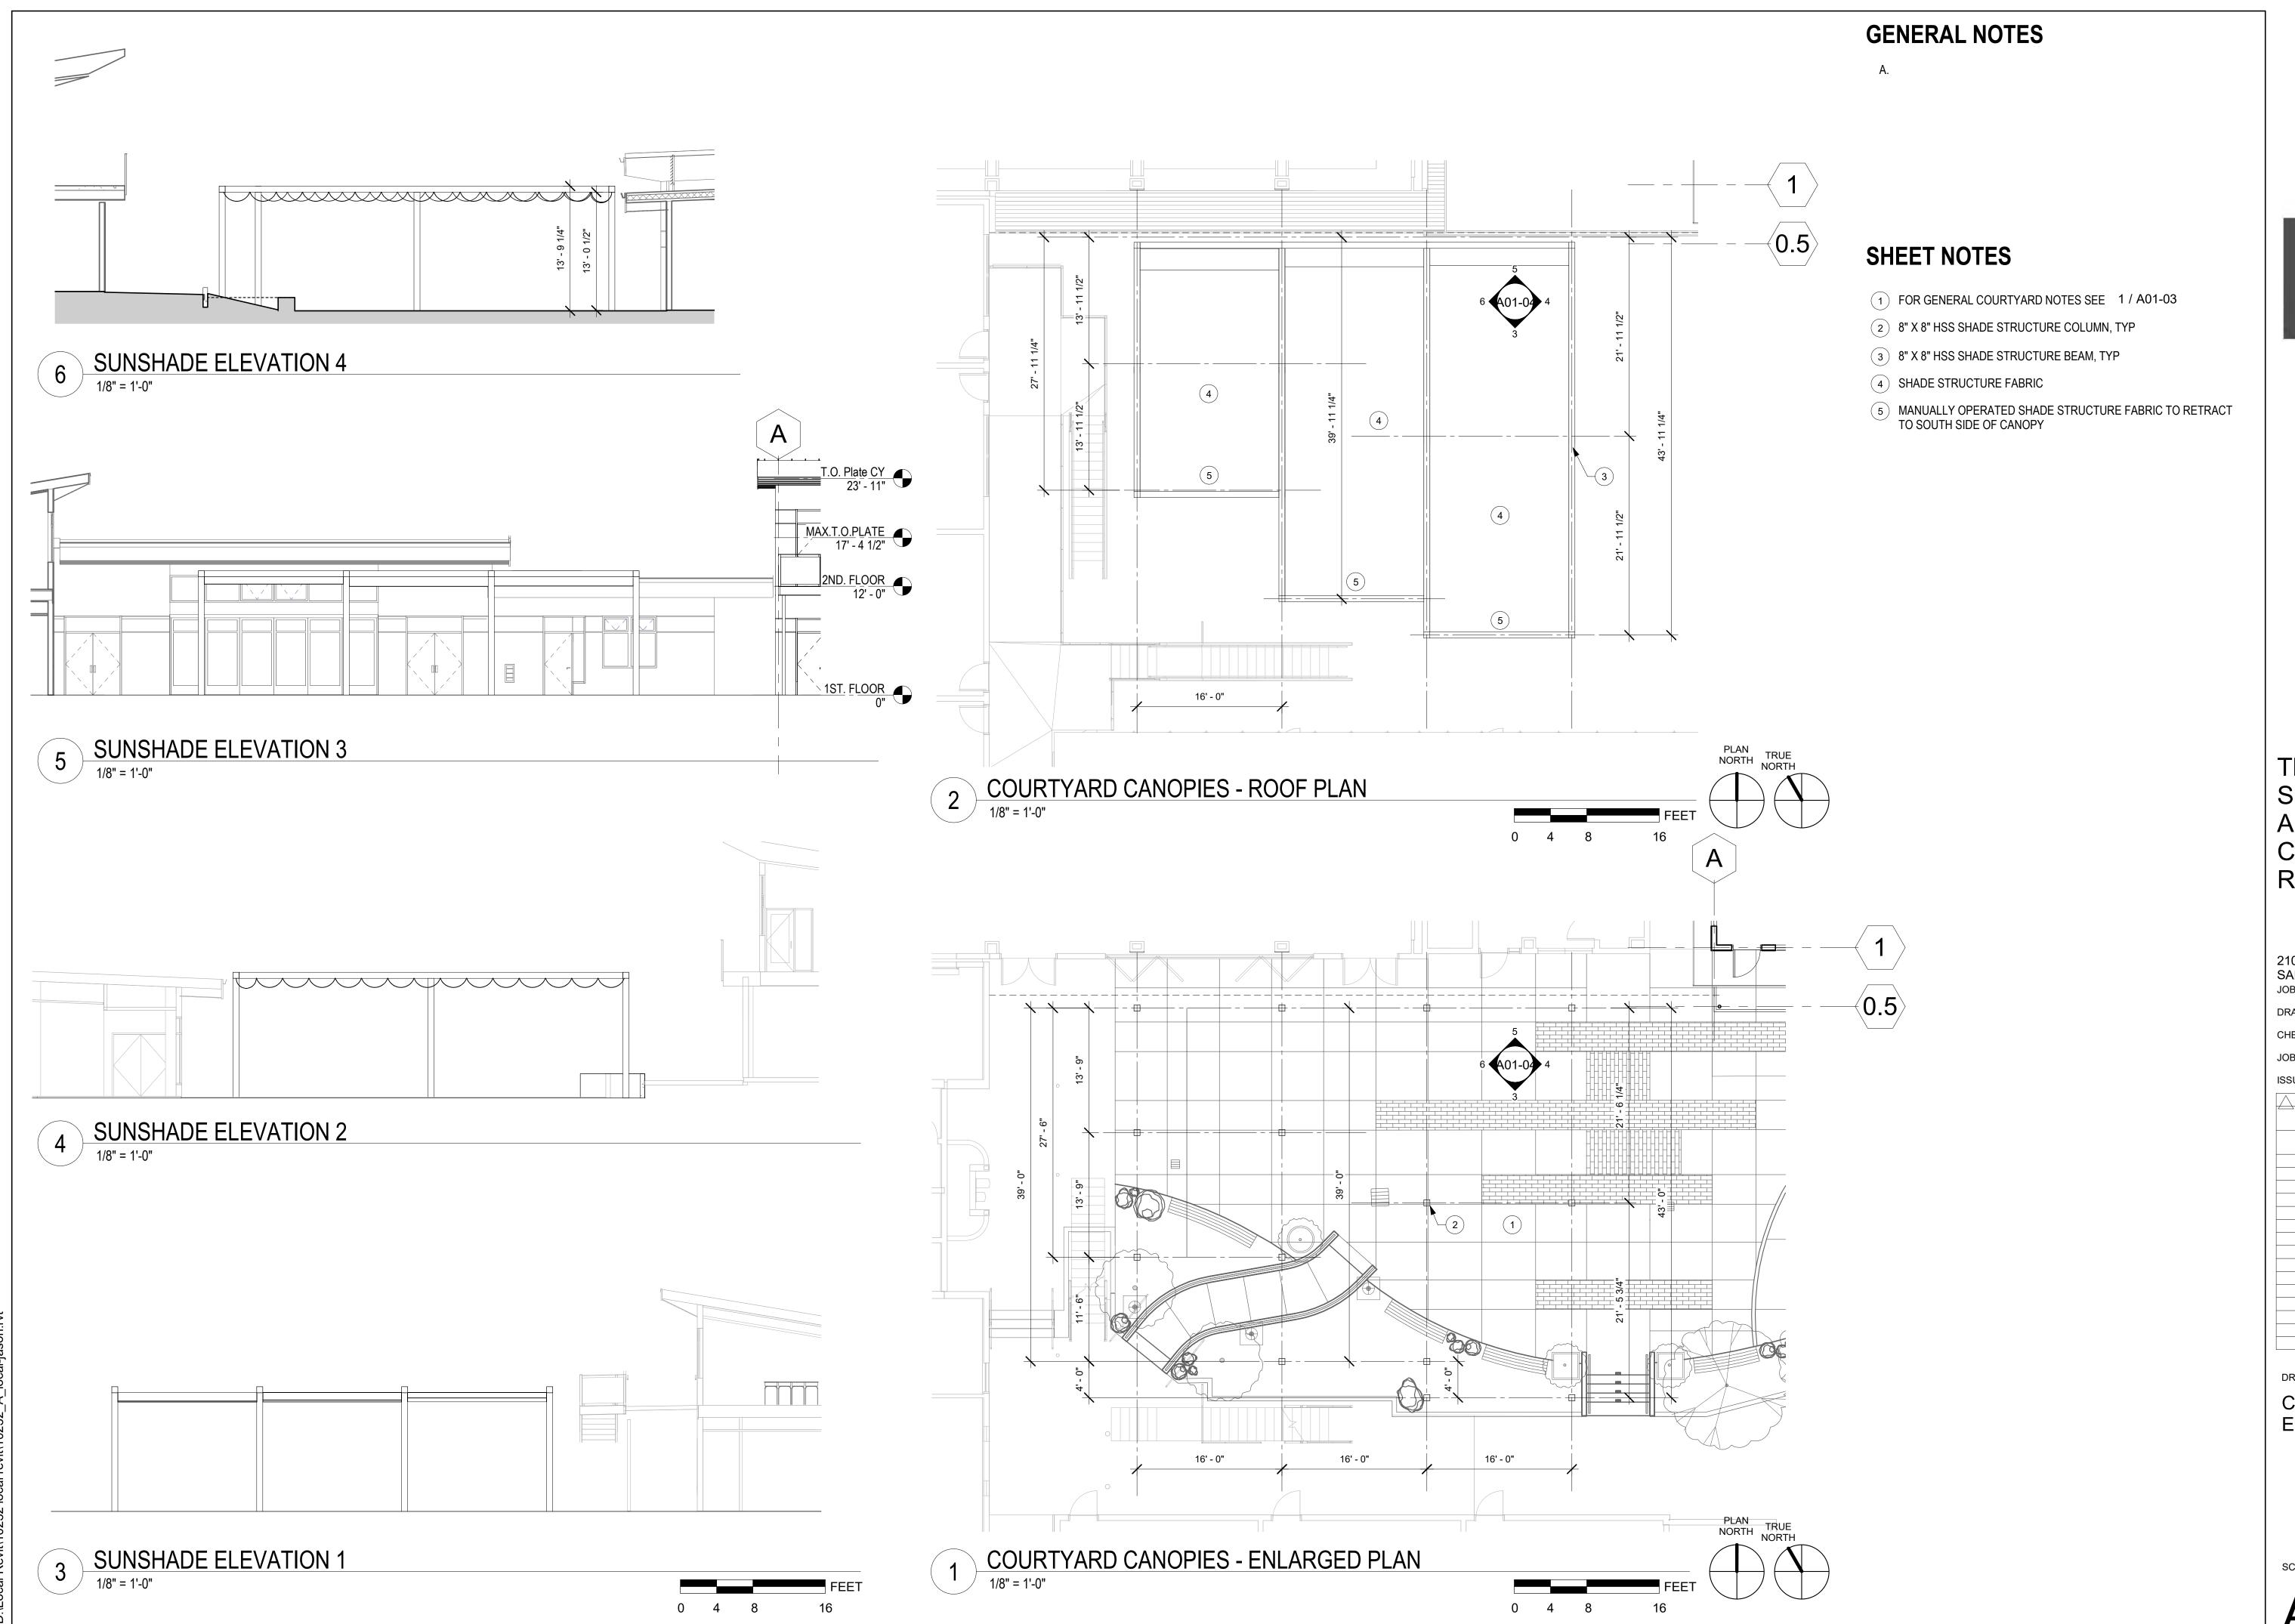
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ENLARGED SITE PLAN

SCALE 1/8" = 1'-

A01-03



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	·	

DRAWING TITLE

CANOPY PLANS AND ELEVATIONS

SCALE 1/8" = 1'-0

A01-02

(E) LOWER LEVEL/ CRAWL SPACE PLAN

1/8" = 1'-0"

GENERAL NOTES - FLOOR PLANS

A. SEE FLOOR PLAN ENLARGEMENTS FOR MORE INFORMATION B. SEE SHEET FOR MAJOR FLOOR LEVEL GRADES C. SEE STRUCTURAL DRAWINGS FOR FOUNDATION DRAWINGS D. FOR ADDITIONAL INFORMATION, SEE STRUCTURAL, MECHANICAL, PLUMBING, ELECTRICAL, CIVIL & LANDSCAPE

1 WALL HUNG - UPRIGHT BIKE STORAGE - "LONG TERM" -



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2019	

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(E) LOWER LEVEL/ CRAWL SPACE PLAN

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SUBMITTAL

JAN. 30, 2019

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DRAWING TITLE

FIRST FLOOR PLAN

CALE 1/9" - 1' C

A02-02

No. C 18083 THE NO. C 18083 THE NO. C 18083 THE NO. C CALLED

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DRAWING TITLE

SECOND FLOOR PLAN

SCALE 1/9" - 1'

A02-03

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JAS JOB CAPTAIN

> DESCRIPTION PLANNING RESUBMITTAL

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DRAWING TITLE **ROOF PLAN**

MAX.T.O.PLATE 17'-41/2' 2ND. FLOOR 12'-0' CRAWL SPACE 5'-2.34" (ELIOWEST GRADE 6'-6-1/2')

EAST ELEVATION

SHEET NOTES

- GUTTER AND DOWNSPOUT CONNECTED TO UNDERGROUND SD SYSTEM
- 2 1-1/8" MARINE GRADE PLYWOOD FASCIA
- 3 7/8" CEMENT PLASTER FINISH SYSTEM, TYPICAL
- 4 1" ALUMINUM REVEAL
- 5 ALUMINUM WINDOW W/ MILLED ALUMINUM FINISH
- 6 HOLLOW METAL DOOR AND FRAME, WITH HOLLOW METAL TRANSOME AND SIDELIGHT WHERE OCCURS
- Tanding Seam Metal Roof; Roof and Building to be PV Ready Per Ordinance ___
- 8 CEDAR SOFFIT TO MATCH EXISTING
- 9 DECORATIVE "OPEN PICKET" STEEL GUARDRAIL
- 10 STEEL STAIR
- (E) STAIR AND EXTERIOR WALKWAY
- (E) GUARDRAIL
- GUARDRAIL TO MATCH EXISTING BALCONY GUARDRAIL
- (14) EXTERIOR WALKWAY (EXIT BALCONY)
- STEEL PIPE COLUMN W/ METALLIC ALUMINUM PAINT, TYPICAL
- 16 SHADE STRUCTURE CANOPY
- 17 CRAWL SPACE
- (E) 1 STORY CLASSROOM BUILDING
- (E) 2 STORY CLASSROOM BUILDING

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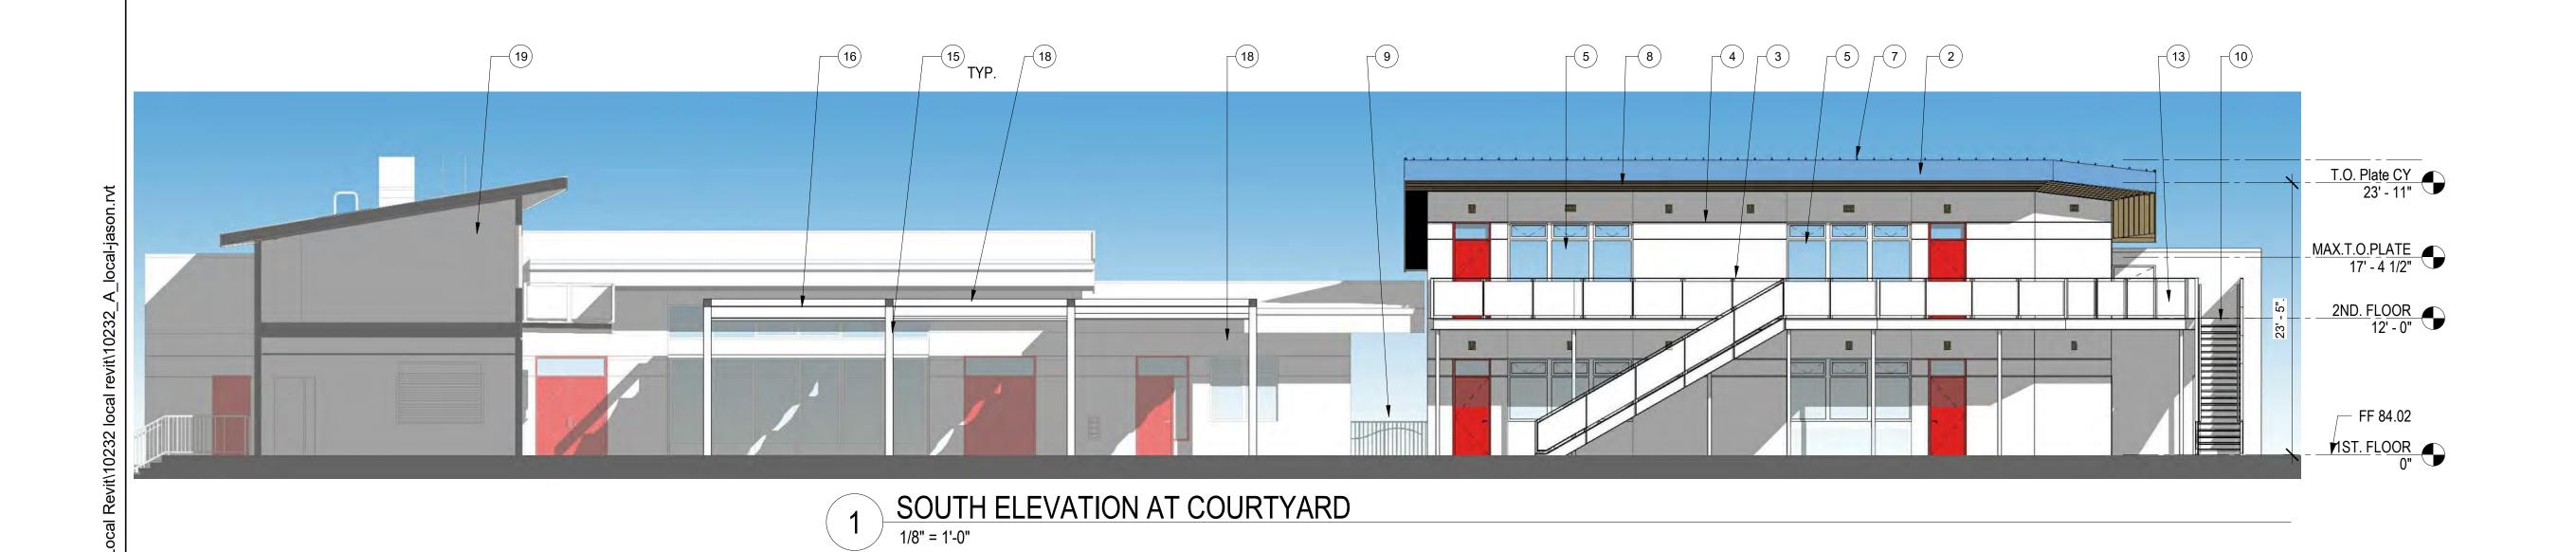
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	2019			

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SOUTH AND EAST EXTERIOR COLOR ELEVATIONS

SCALE 1/8" = 1

A03-01A
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NORTH EXTERIOR ELEVATION - Planning
1/8" = 1'-0"

2ND. FLOOR 12' - 0"

1ST. FLOOR 0"

CRAWL SPACE -5' -2 3/4"

(E) LOWEST GRADE -6' - 6 1/2"

----- 77.47

FF 84.02

- 10 STEEL STAIR
- (E) STAIR AND EXTERIOR WALKWAY
- (E) GUARDRAIL
- GUARDRAIL TO MATCH EXISTING BALCONY GUARDRAIL
- 16 NOT USED

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NORTH AND WEST **EXTERIOR COLOR ELEVATIONS**





1 GUTTER AND DOWNSPOUT

2 WOOD FASCIA

3 CEMENT PLASTER FINISH SYSTEM, TYPICAL

4 1" ALUMINUM REVEAL

5 ALUMINUM WINDOW W/ MILLED ALUMINUM FINISH

6 HOLLOW METAL DOOR AND FRAME, WITH HOLLOW METAL TRANSOME AND SIDELIGHT WHERE OCCURS

7 STANDING SEAM METAL ROOF


8 LOCATION OF MAX. PLATE HEIGHT ABOVE LOWEST ADJACENT GRADE

9 LIGHT FIXTURE - S.E.D.

14) EXTERIOR WALKWAY (EXIT BALCONY)

(E) 1 STORY CLASSROOM BUILDING

(E) 2 STORY CLASSROOM BUILDING

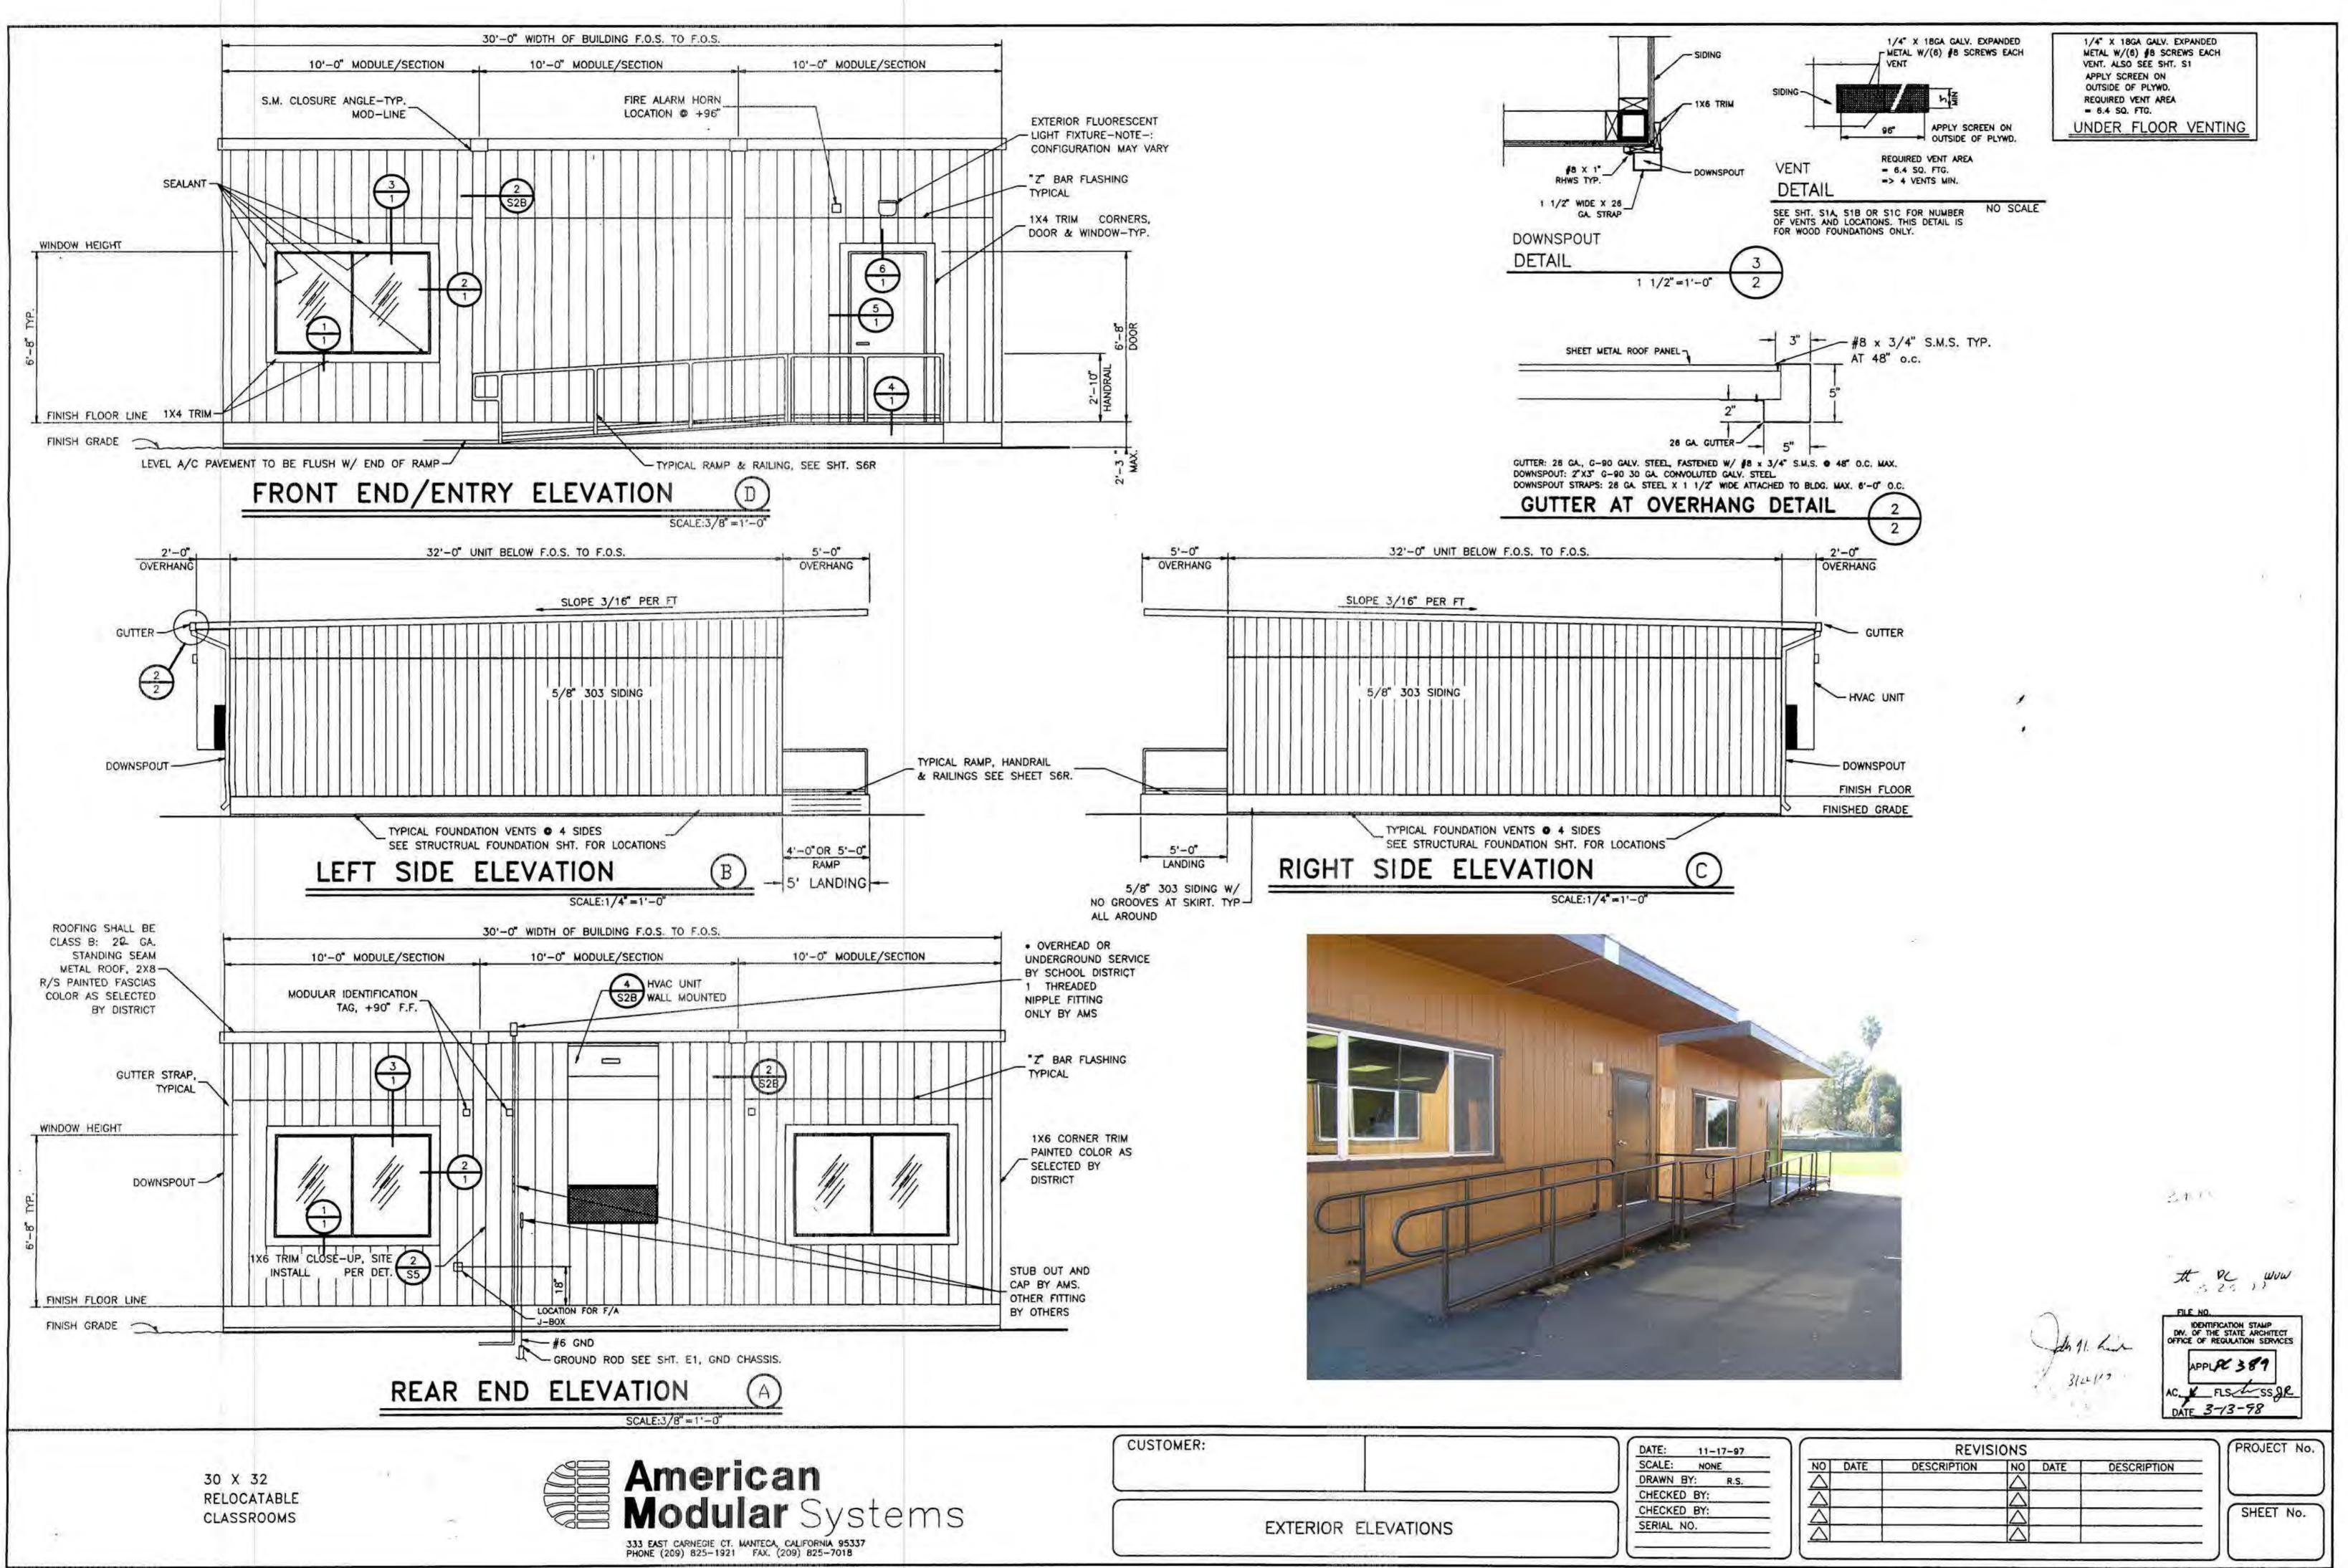

- PAR WILL \$ 1 - 1 -

SHEET NOTES


2 A03-04

MAX.T.O.PLATE 17' - 4 1/2"

2ND. FLOOR 12' - 0"

1ST. FLOOR 0"

CRAWL SPACE (E) LOWES-5' - 12 3/4" -6' - 6 1/2" 1 32'-0" MAX RIDGE HEIGHT

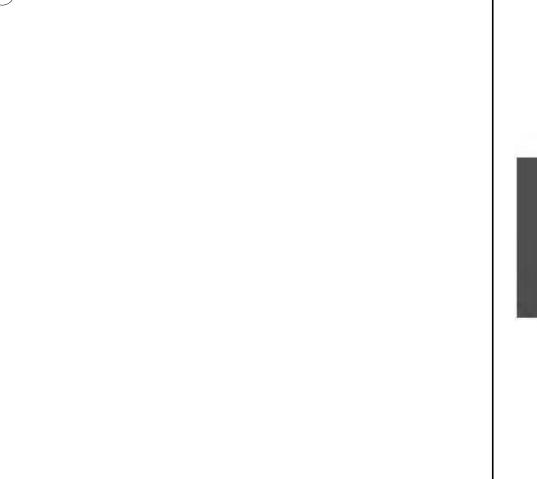

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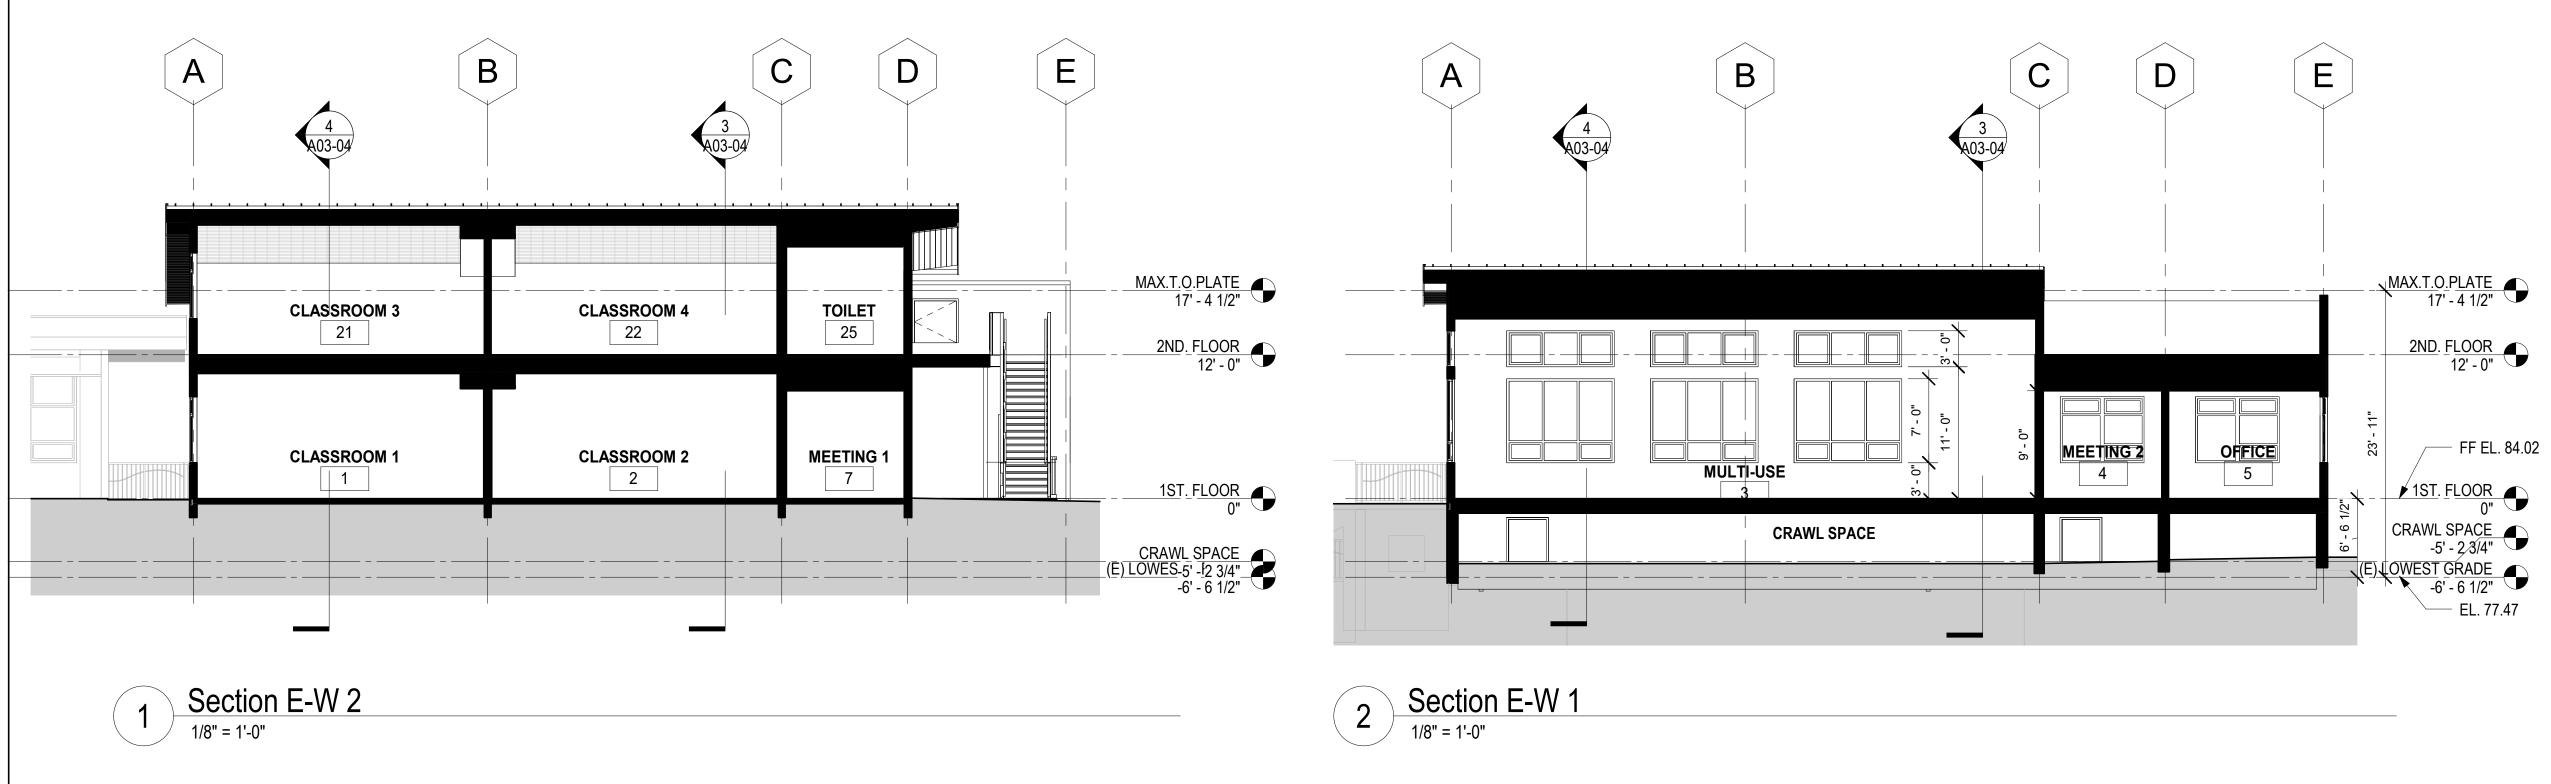
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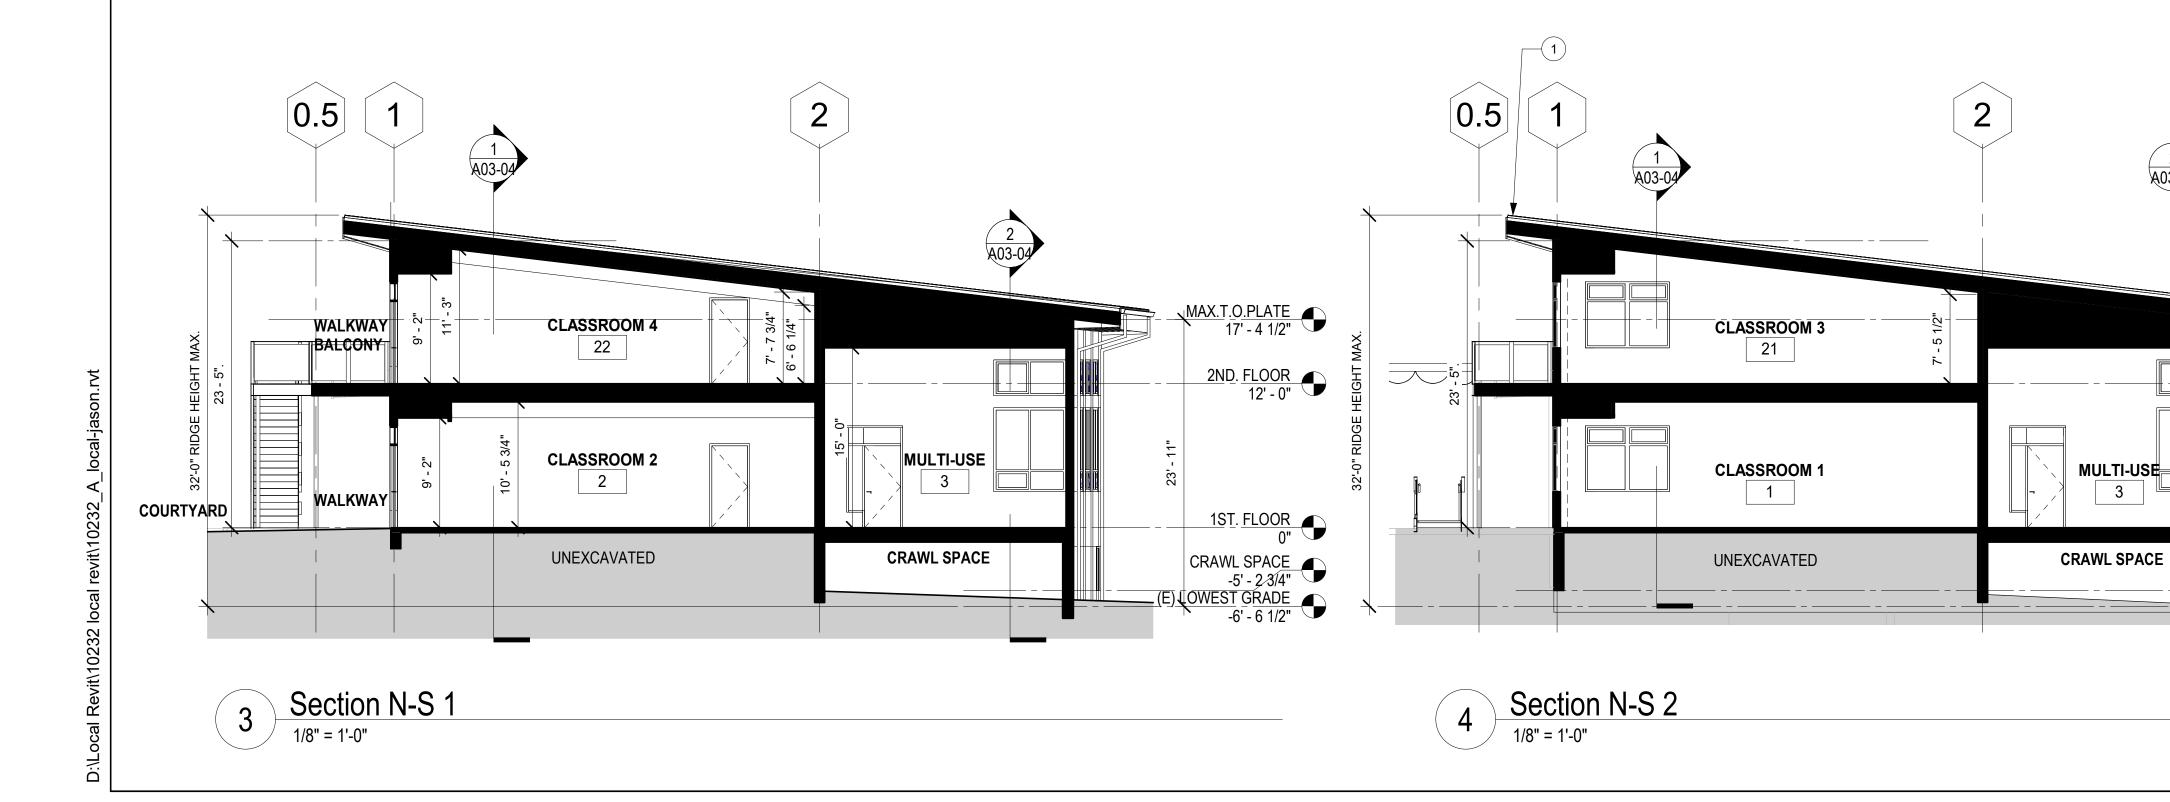
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BUILDING SECTIONS

SCALE 1/8" = 1'-0

A03-04
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		2200
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COURTYARD RENDERING







THE CAREY SCHOOL ADDITION & COURTYARD REMODEL

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PLANNING RESUBMITTAL

DRAWING TITLE

VIEW FROM NORTH RENDERING

SCAL

A05-02A
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GENERAL NOTES

- 1. VERIFY EXISTING CONDITIONS IN FIELD.
- 2. AREAS DAMAGED OR AFFECTED BY THIS WORK SHALL BE REPAIRED OR REPLACED TO MATCH EXISTING U.O.N.
- 3. VERIFY THE EXACT LOCATION AND MOUNTING HEIGHT OF WALL, FLOOR AND CEILING MOUNTED EQUIPMENT WITH THE ARCHITECT.
- 4. PROVIDE CONDUIT AND WIRING AS REQUIRED FOR CIRCUITING AND SWITCHING SHOWN.
- 5. CONDUIT SHALL BE RUN CONCEALED IN WALLS AND CEILINGS OR UNDER FLOOR AT ALL NEW WORK AREAS.
- 6. PROVIDE TYPEWRITTEN PANELBOARD DIRECTORIES.
- 7. CONNECT TO EXISTING CENTRALIZED LIGHTING CONTROL SYSTEM FOR EXTERIOR LIGHTING AT NEW BUILDING.

DRAWING LIST

EOO-O1 ELECTRICAL LEGEND, FIXTURE SCHEDULE, AND DETAILS

E01-02 ELECTRICAL SITE PLAN E02-02 ELECTRICAL FIRST FLOOR POWER AND LOW VOLTAGE PLAN

E02-03 ELECTRICAL SECOND FLOOR POWER AND LOW VOLTAGE PLAN E02-04 ELECTRICAL ROOF POWER AND LOW VOLTAGE PLAN

E03-02 ELECTRICAL FIRST FLOOR LIGHTING PLAN

E03-03 ELECTRICAL SECOND FLOOR LIGHTING PLAN

E04-01 ELECTRICAL SINGLE LINE DIAGRAM

FIRE ALARM SYSTEM

1. PROVIDE DESIGN BUILD FOR ALARM SYSTEM ADDITIONS.

a) FULLY AUTOMATIC AT NEW BUILDING. b) VOICE EVACUATION FOR NEW BUILDING

AND UPGRADE EXISTING BUILDING.

2. SUBMIT TO SAN MATEO FIRE DEPARTMENT FOR PLAN REVIEW AND PERMIT.

	$\frac{2}{E00.01}$ LIGHTIN	IG FIXTURE SCHEDI	JLE	
TYPE	DESCRIPTION	MANUFACTURER AND CATALOG NUMBER	WATTS	MOUNTING
A	SURFACE MOUNTED LED 4'	HE WILLIAMS #ASM-4-L46/835-S-S-A-DIM-UNV	42	SURFACE
B	SURFACE MOUNTED 2x2 FLAT PANEL LED	METALUX #22SP3435/SP-SURDSKFKIT	32	SURFACE
C	40' PENDANT DIR/IND. LED	FINELITE #S12LEDID-DCO-40-3E-V-V-835- OPEN-120V-SC-FA-FE-C4	573	PENDNAT CABLE
D	VANITY LED	FINELITE #S17LED-VCF-PF-2-V-830-120-SC	18.4	WALL ABOVE MIRROR
E	SURFACE DOWNLIGHT LED	DMF #DRDHN-JO-DRD5S-4-R-10-9-30	12	SURFACE ON RECESSED OUTLET
F	EXTERIOR LED AREA LIGHT SIMILAR TO EXISTING WITH 2 LEVEL MOTION SENSOR CONTROL	GARDCO #P26140L-1150-NW-G2-WS-2-120 -BL-IMR3-BZ	52	WALL
(F1)	EXTERIOR LED PATHWAY LIGHT	RAB #SLIM-26-N	29	WALL
G	2x2 RECESSED LED	FINELITE #HPR-LED-A-2X2-DCO-B-835-120- SC-C1		RECESSED T-BAR
H	LED STRIP	KELVIX #PH41K-WR-24V. PROVIDE TRANSFORMER.		UNDER BENCH
	STEP LIGHT LED	WINONA #STEP13WL-6LONG-L-LST2A-WHT40K- MVOLT-BA		RECESSED STEP LIGHT
J	BOLLARD LED	ERCO CASTER #33287.00		CONCRETE BASE
(x)	EMERGENCY LED EXIT SIGN WITH LIGHT HEADS	CHLORIDE #CLC-N-GW		SURFACE WALL/CEILING
Z	INTERIOR EMERGENCY FIXTURE WITH WIRE GUARD	CHLORIDE #CLU2-N-W		SURFACE WALL
(Z1)	EXTERIOR EMERGENCY LIGHT FIXTURE LED	DUALLITE #PG-Z-HTR		SURFACE WALL

FIXTURE SCHEDULE NOTES:

- 1. ALL INTERIOR FIXTURES SHALL BE 3500°K AND ALL EXTERIOR SHALL BE 4000°K
- 2. GENERAL FIXTURE NUMBERS ARE INDICATED. CONTRACTOR
- SHALL PROVIDE ALL ACCESSORIES AS REQUIRED FOR A COMPLETE SYSTEM.

The Carey School Schematic Scope 1⁵¹ & 2nd Grade Classroom Building

POWER

1. Electrical Room will house the electrical panels and wall-mounted IDF.

- 2. 400A feed from the main switchboard.
- 3. The existing Panel C, that serves the existing classroom, is in the adjacent building and is only 125A, single phase and shall be disconnected from removed building.

1. New wall-mounted IDF in the Electrical Room will serve data in the new building.

2. Provide 12 strand fiber from MDF to IDF and Cat6 to outlets.

- 1. New fire alarm at the new building will be fully automatic voice evacuation.
- 2. Provide new fire alarm panel with voice evacuation for the full campus per the San Mateo Fire Department.
- 3. Provide carbon monoxide detection in all classrooms (existing and new) with gas-fired appliances (furnaces).

- 1. All interior lighting will be LED with automatic shutoff, (motion sensors), dimming (where required), and daylight harvesting (where applicable).
- a. The interior lighting style will depend on the final building design, but we propose cable hung direct/indirect in the multi-use and surface in other rooms.
- 2. Exterior lighting will be LED and connected to the existing control system.
- a. Courtyard, balcony, and stairs will have general illumination from the buildings with accent lighting in the courtyard as determined by the landscape architect.

	LEGEND
--	--------

AUDIO VISUAL SYSTEM CEILING OR FLOOR OUTLET.

CABLE BETWEEN AV OUTLETS.

SWITCH, 3-WAY +42"

MOTOR OUTLET.

FLUSH IN FINISHED AREAS.

MAGNETIC MOTOR STARTER

MOTOR DISCONNECT SWITCH.

PANELBOARD- SEE SCHEDULE

GROUND WIRE WITH ALL CIRCUITS.

TELEPHONE CONDUIT & CABLE

DATA CONDUIT & CABLE

TELEPHONE/DATA CABLES.

OR LIGHT FIXTURE.

AUDIO/VISUAL CONDUIT & WIRING

FIRE ALARM CONDUIT/CABLE(S).

CONDUIT STUB AND CAP OR BUSHING.

CONDUIT/CABLE TURNING UP OR DOWN.

LOW VOLTAGE CONTROL WIRING. 3/C #18 FOR

FLEXIBLE CONDUIT CONNECTION TO EQUIPMENT

OCCUPANCY SENSORS, 2#18 PURPLE/GREY FOR 0-10V.

CONDUIT AND/OR WIRING IN OR UNDER FLOOR.

CONDUIT AND/OR WIRING HOMERUN TO PANEL OR EQUIPMENT AS NOTED.

\$3

 \bigcirc \bigcirc \rightarrow

--D--

→

____T/D____

——AV——

— F —

—~

PROVIDE RAPID RUN CABLE BETWEEN AV OUTLETS.

THERMAL OVERLOAD OR FUSTAT SWITCH +42" U.O.N.

AUDIO VISUAL SYSTEM WALL OUTLET. PROVIDE RAPID RUN

JUNCTION BOX (NOT ALL SHOWN). SIZE AS REQUIRED BY CODE, WITH B.M.C.; BLANK STAINLESS STEEL COVER WHERE

CONDUIT AND WIRING CROSSLINES INDICATES QUANTITY OF PHASE & NEUTRAL CONDUCTORS WHEN MORE THAN 2. NO CROSSLINES INDICATES 2#12 + #12G CONDUCTORS, OTHER SIZES OF CONDUCTORS INDICATED BY NOTATION. PROVIDE

CONDUIT AND/OR WIRING CONCEALED IN WALLS AND/OR CEILING.

	LEGEND		
SYMBOL	DESCRIPTION	SYMBOL	DESCRIPTION
	LIGHT DOTTED OR CROSS HATCHED LINES & SYMBOLS INDICATE EXISTING TO BE REMOVED.	AFF AV CKT, Œ	ABOVE FINSHED FLOOR AUDIO VISUAL CIRCUIT
\$ ⊕ ○ ♥ \$ \$° O₂°	LIGHT LINES AND SYMBOLS INDICATE EXISTING TO REMAIN HEAVY LINES AND SYMBOLS INDICATE NEW WORK NUMERALS ADJACENT TO SYMBOLS INDICATES CIRCUIT. LOWER CASE LETTERS ADJACENT TO SYMBOL INDICATES CONTROL FROM CORRESPONDING SWITCH OR OCCUPANCY SENSOR.	C C.O. CL D (E)	CONDUIT CONDUIT ONLY CLOCK SYSTEM DATA EXISTING
о О	DOWNLIGHT-SEE FIXTURE SCHEDULE LIGHT FIXTURE WALL MOUNT-SEE FIXTURE SCHEDULE.	EL FA FO	EARLY LIGHT DUSK TO PRESET TIME OFF FIRE ALARM FIBER OPTIC
□ □ □ □ □ □ □ □ □ □ □ □ □ □ □ □ □ □ □	LED FIXTURE—SEE FIXTURE SCHEDULE. EMERGENCY EXIT SIGN—SEE FIXTURE SCHEDULE	GFI G, GND MSL	GROUND FAULT INTERRUPTER GROUND MORNING TO DAWN LIGHTING CONTROL
(A)	EMERGENCY LIGHT HEAD UNIT—SEE FIXTURE SCHEDULE LIGHTING FIXTURE TYPE NOTATION.	MEL (N)	MORNING TO PRESET TIME OFF LIGHTING CONTROL NEW
② ₩ ₩	SHEET NOTE IDENTIFICATION TAG, SEE "SHEET NOTES" ON RESPECTIVE DRAWINGS. GROUND FAULT INTERRUPTER RECEPTACLE. CEILING MOUNTED RECEPTACLE.	NL NTS NIC	NIGHT LIGHT NOT TO SCALE NOT TO CONTRACT
₩	20 AMP, VAC DUPLEX RECEPTACLE; COOPER #5362W, HUBBELL OR APPROVED EQUAL +18" U.O.N. 20 AMP, 125 VAC FOURPLEX RECEPTACLE; (2) COOPER #5362W IN COMMON BOX, HUBBELL OR APPROVED EQUAL +18" U.O.N.	PA PC (R) (RL)	PUBLIC ADDRESS PHOTOCELL REMOVE RELOCATE
И	DATA OUTLET 4 11/16" SQ. x 2 1/8" DEEP BOX WITH SINGLE GANG RING AND 2/RJ45 JACK WITH COVER PLATE AND 2-CAT6 CABLES TO IDF PATCH PANEL +18", U.O.N. (#) INDICATES NUMBER OF JACKS AND CABLES IF MORE THAN 2. PROVIDE 1"C. IDF.	SL T TS	SECURITY LIGHT DUSK TO DAWN TELEPHONE TIME SWITCH
K	TELEPHONE/DATA OUTLET 4 11/16" SQ. x 2 1/8" DEEP BOX WITH SINGLE GANG RING & 2/RJ45 DATA JACKS & 1 CAT 3 TELEPHONE JACK & COVER PLATE +18" U.O.N., 3-CAT6 DATA CABLES TO IDF CABLE TO TELEPHONE BACKBOARD. PROVIDE 1"C. TO IDF.	U.G. U.O.N. WP	UNDERGROUND UNLESS OTHERWISE NOTED WEATHERPROOF
cs _H	PROJECTION CONTROL STATION. PROVIDE 4" SQUARE BOX WITH SINGLE GANG RING AND 3/4"C.O. TO PROJECTOR LOCATION AND PROVIDE OUTLET BOX AT PROJECTOR.		
WP Fd	FIRE ALARM WEATHERPROOF SPEAKER.		
s p	FIRE ALARM SPEAKER/STROBE WHEELLOCK #AS-24MCW-FR +80" FIRE ALARM CEILING SPEAKER FIRE ALARM STROBE		
(SD)	SMOKE DETECTOR		
©⊕]	CLOCK & SPEAKER COMBINATION TO MATCH EXISTING SIMPLEX		



DATE SIGNED: Jan 29,19



BWF Consulting Engineers 220 SO. SPRUCE AVENUE, SUITE 203 SO. SAN FRANCISCO, CALIFORNIA 94080 (650) 871-0220

THE CAREY SCHOOL **ADDITION &** COURTYARD REMODEL

2103 ALAMEDA DE LAS PULGAS

M.V.

SAN MATEO, CA 94403 JOB NO. 10232 DRAWN S.M.


JOB CAPTAIN M.V.

CHECKED

ISSUE DESCRIPTION 100% SCHEMATIC DESIGN 11-16-18 01-30-19 PLANNING RESUBMITTAL

DRAWING TITLE **ELECTRICAL** LEGEND, FIXTURE SCHEDULE AND **DETAILS**

SCALE AS NOTED

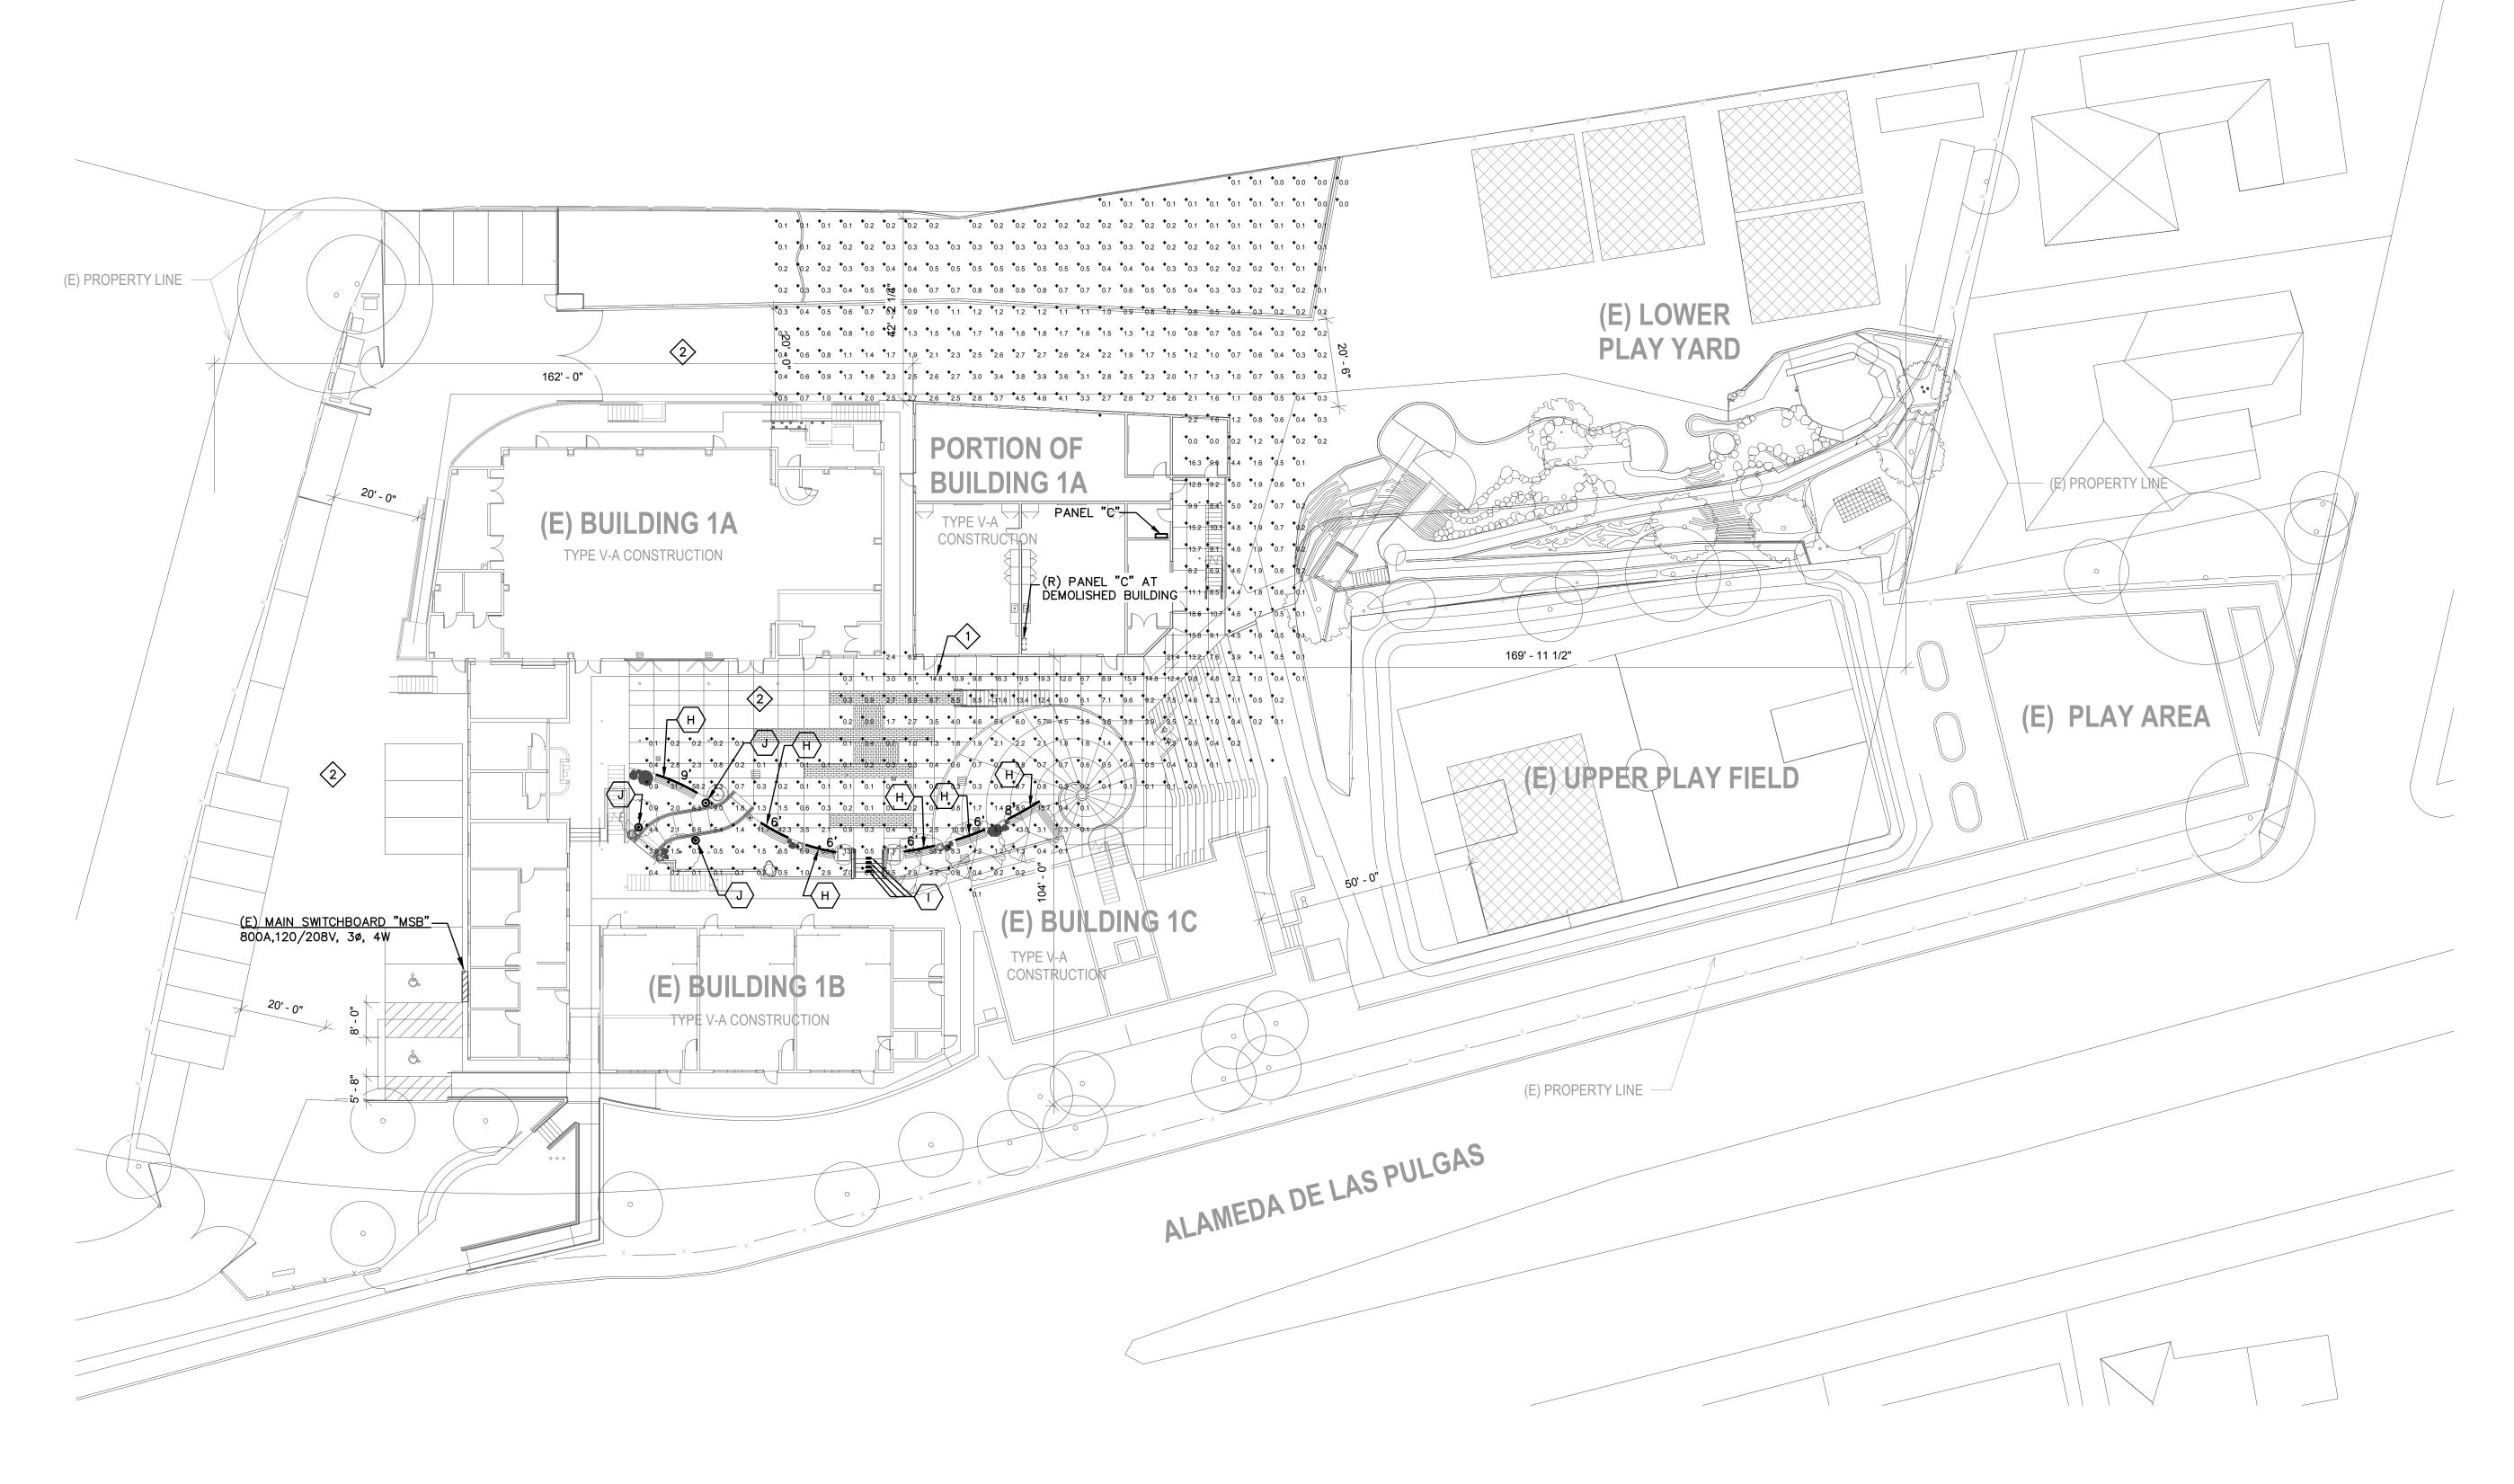




SHEET NOTES:

1) CALCULATED LIGHT LEVEL AT GRADE TYPICAL.

SEE PHOTOMETRIC STUDY FOR 2013 PROJECT FOR THIS AREA.

HIKITI ARCHITECTS

538 NINTH STREET SUITE 240 • OAKLAND, CA 94607

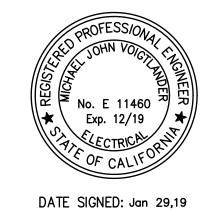



18055
JOB NUMBER

BWF CONSULTING ENGINEERS
ELECTRICAL ENGINEERS
220 SO. SPRUCE AVENUE, SUITE 203
SO. SAN FRANCISCO, CALIFORNIA 94080
(650) 871-0220

THE CAREY SCHOOL ADDITION & COURTYARD REMODEL

2103 ALAMEDA DE LAS PULGAS SAN MATEO, CA 94403

JOB NO. 10232
DRAWN S.M.
CHECKED M.V.
JOB CAPTAIN M.V.


ISS	UE	
	DATE	DESCRIPTION
	11-16-18	100% SCHEMATIC DESIGN
	01-30-19	PLANNING RESUBMITTAL
		· · · · · · · · · · · · · · · · · · ·

ELECTRICAL
SITE PLAN

SCALE AS NOTED

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E01-02

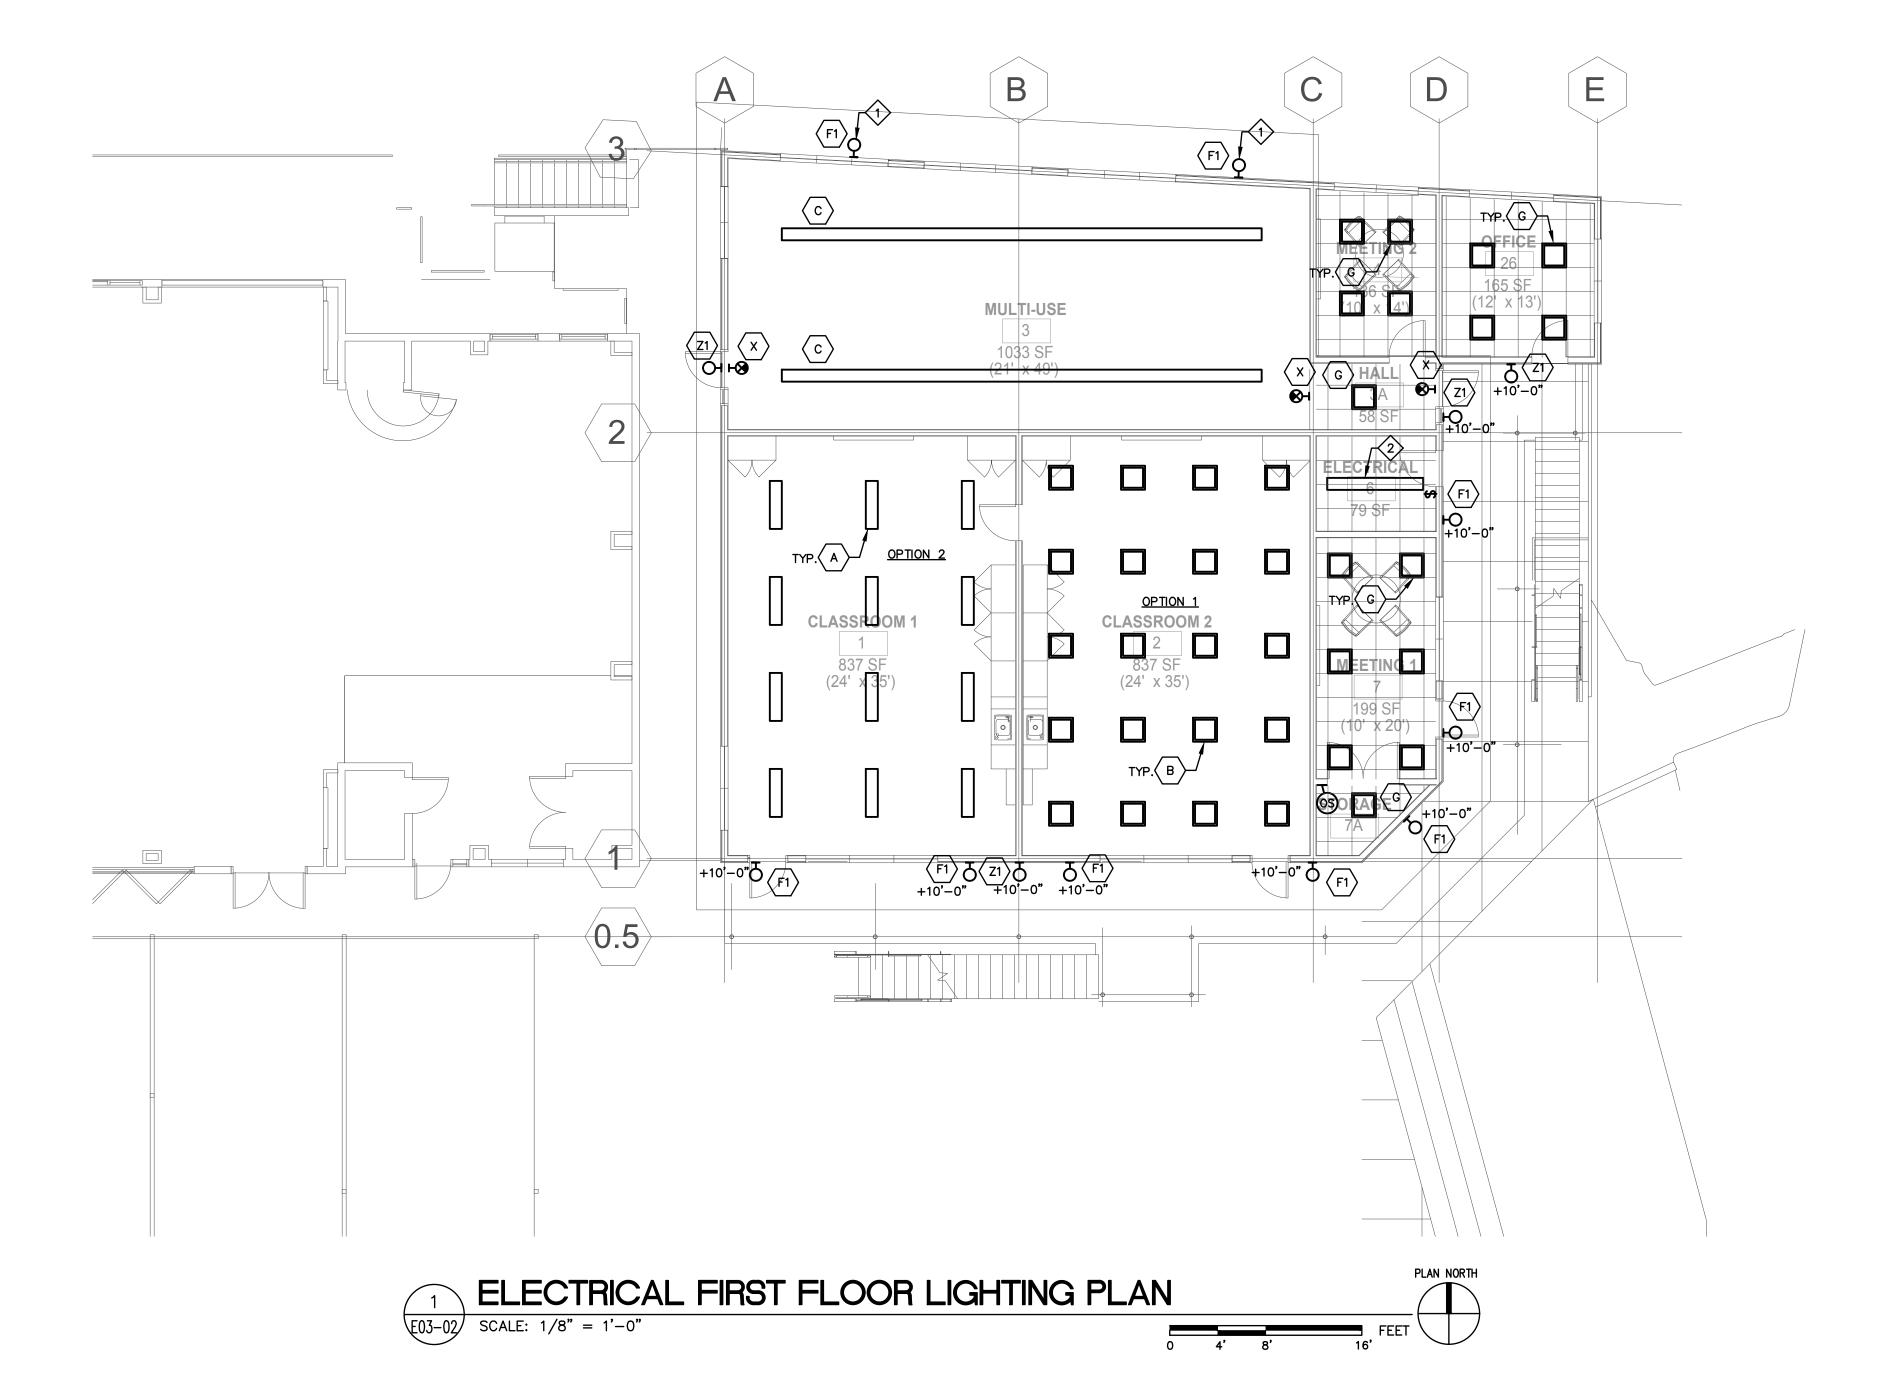

SHEET NOTES:


11'-0" ABOVE 1ST FLOOR TO TOP OF FIXTURE ±18' ABOVE GRADE.

2 STRIP LED.

GENERAL NOTES:

 PROVIDE T24 CONTROLS (AUTO SHUT OFF, DIMMING, DAYLIGHT CONTROL).



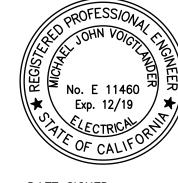

DATE SIGNED: Jan 29,19



JOB NUMBER

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ELECTRICAL ENGINEERS

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CHECKED M.V.

JOB CAPTAIN M.V.

ISS	UE	
	DATE	DESCRIPTION
	11-16-18	100% SCHEMATIC DESIGN
	01-30-19	PLANNING RESUBMITTAL

DRAWING TITLE


ELECTRICAL

FIRST FLOOR

LIGHTING PLAN

SCALE AS NOTED

F03-02

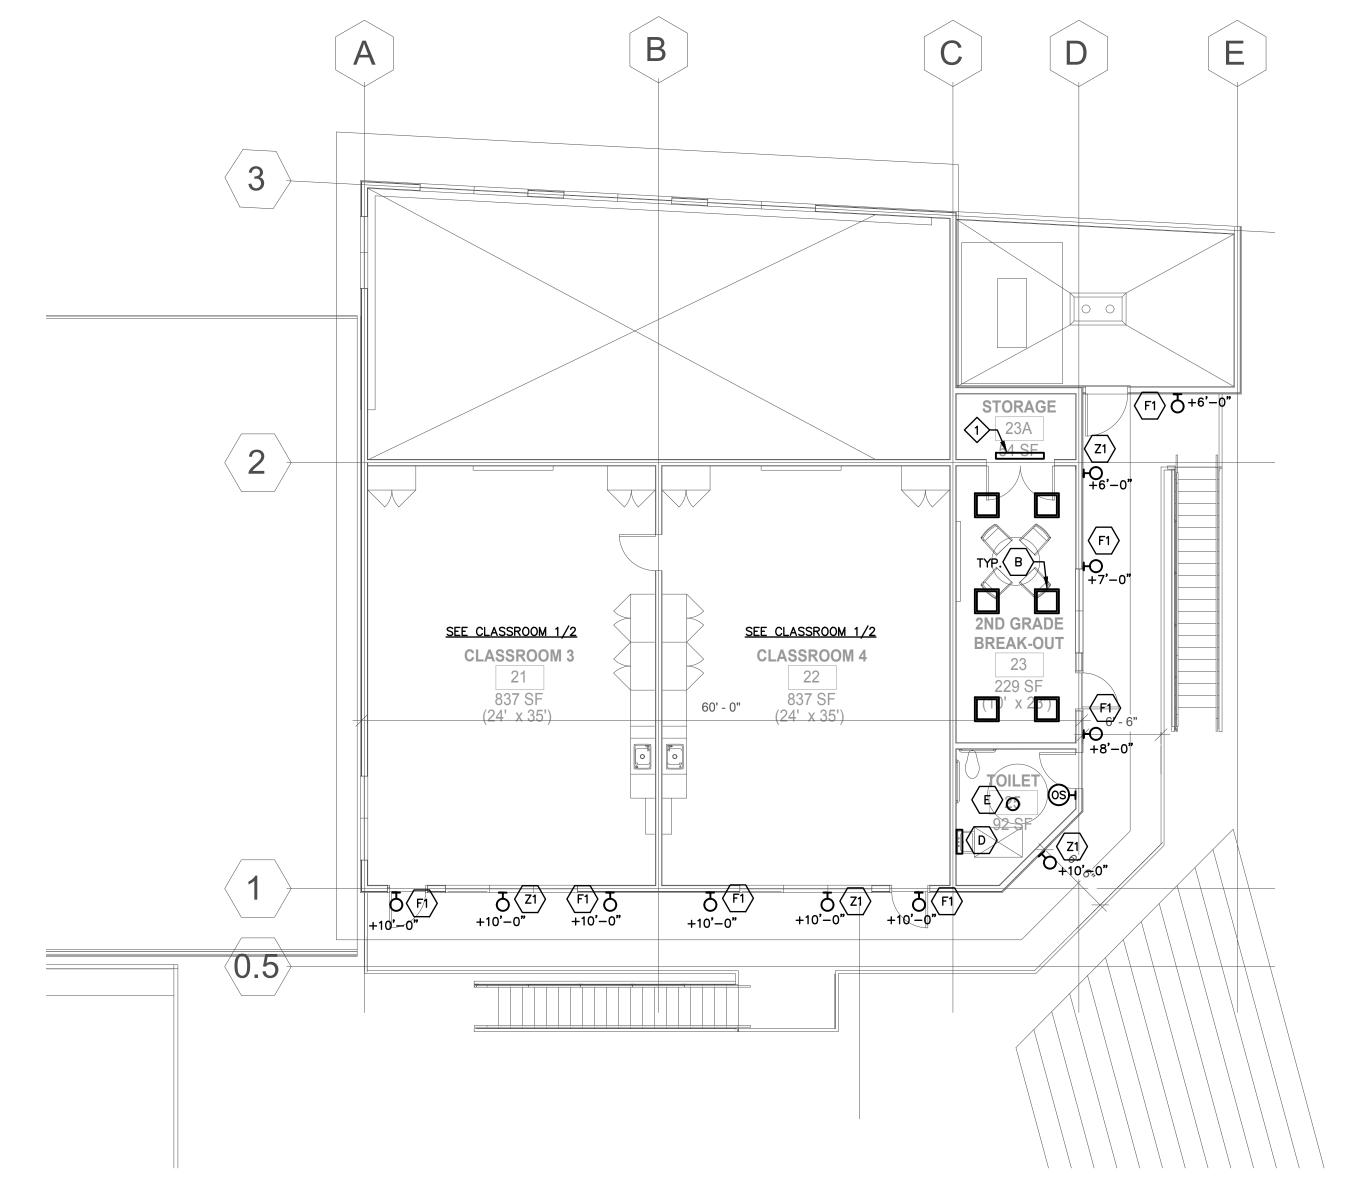

ELECTRICAL SECOND FLOOR LIGHTING PLAN

1 ELECTRICA E03-03 SCALE: 1/8" = 1'-0"

SHEET NOTES: STRIP LED.

DATE SIGNED: Jan 29,19

ARCHITECTS



BWF Consulting Engineers

220 SO. SPRUCE AVENUE, SUITE 203 SO. SAN FRANCISCO, CALIFORNIA 94080 (650) 871-0220

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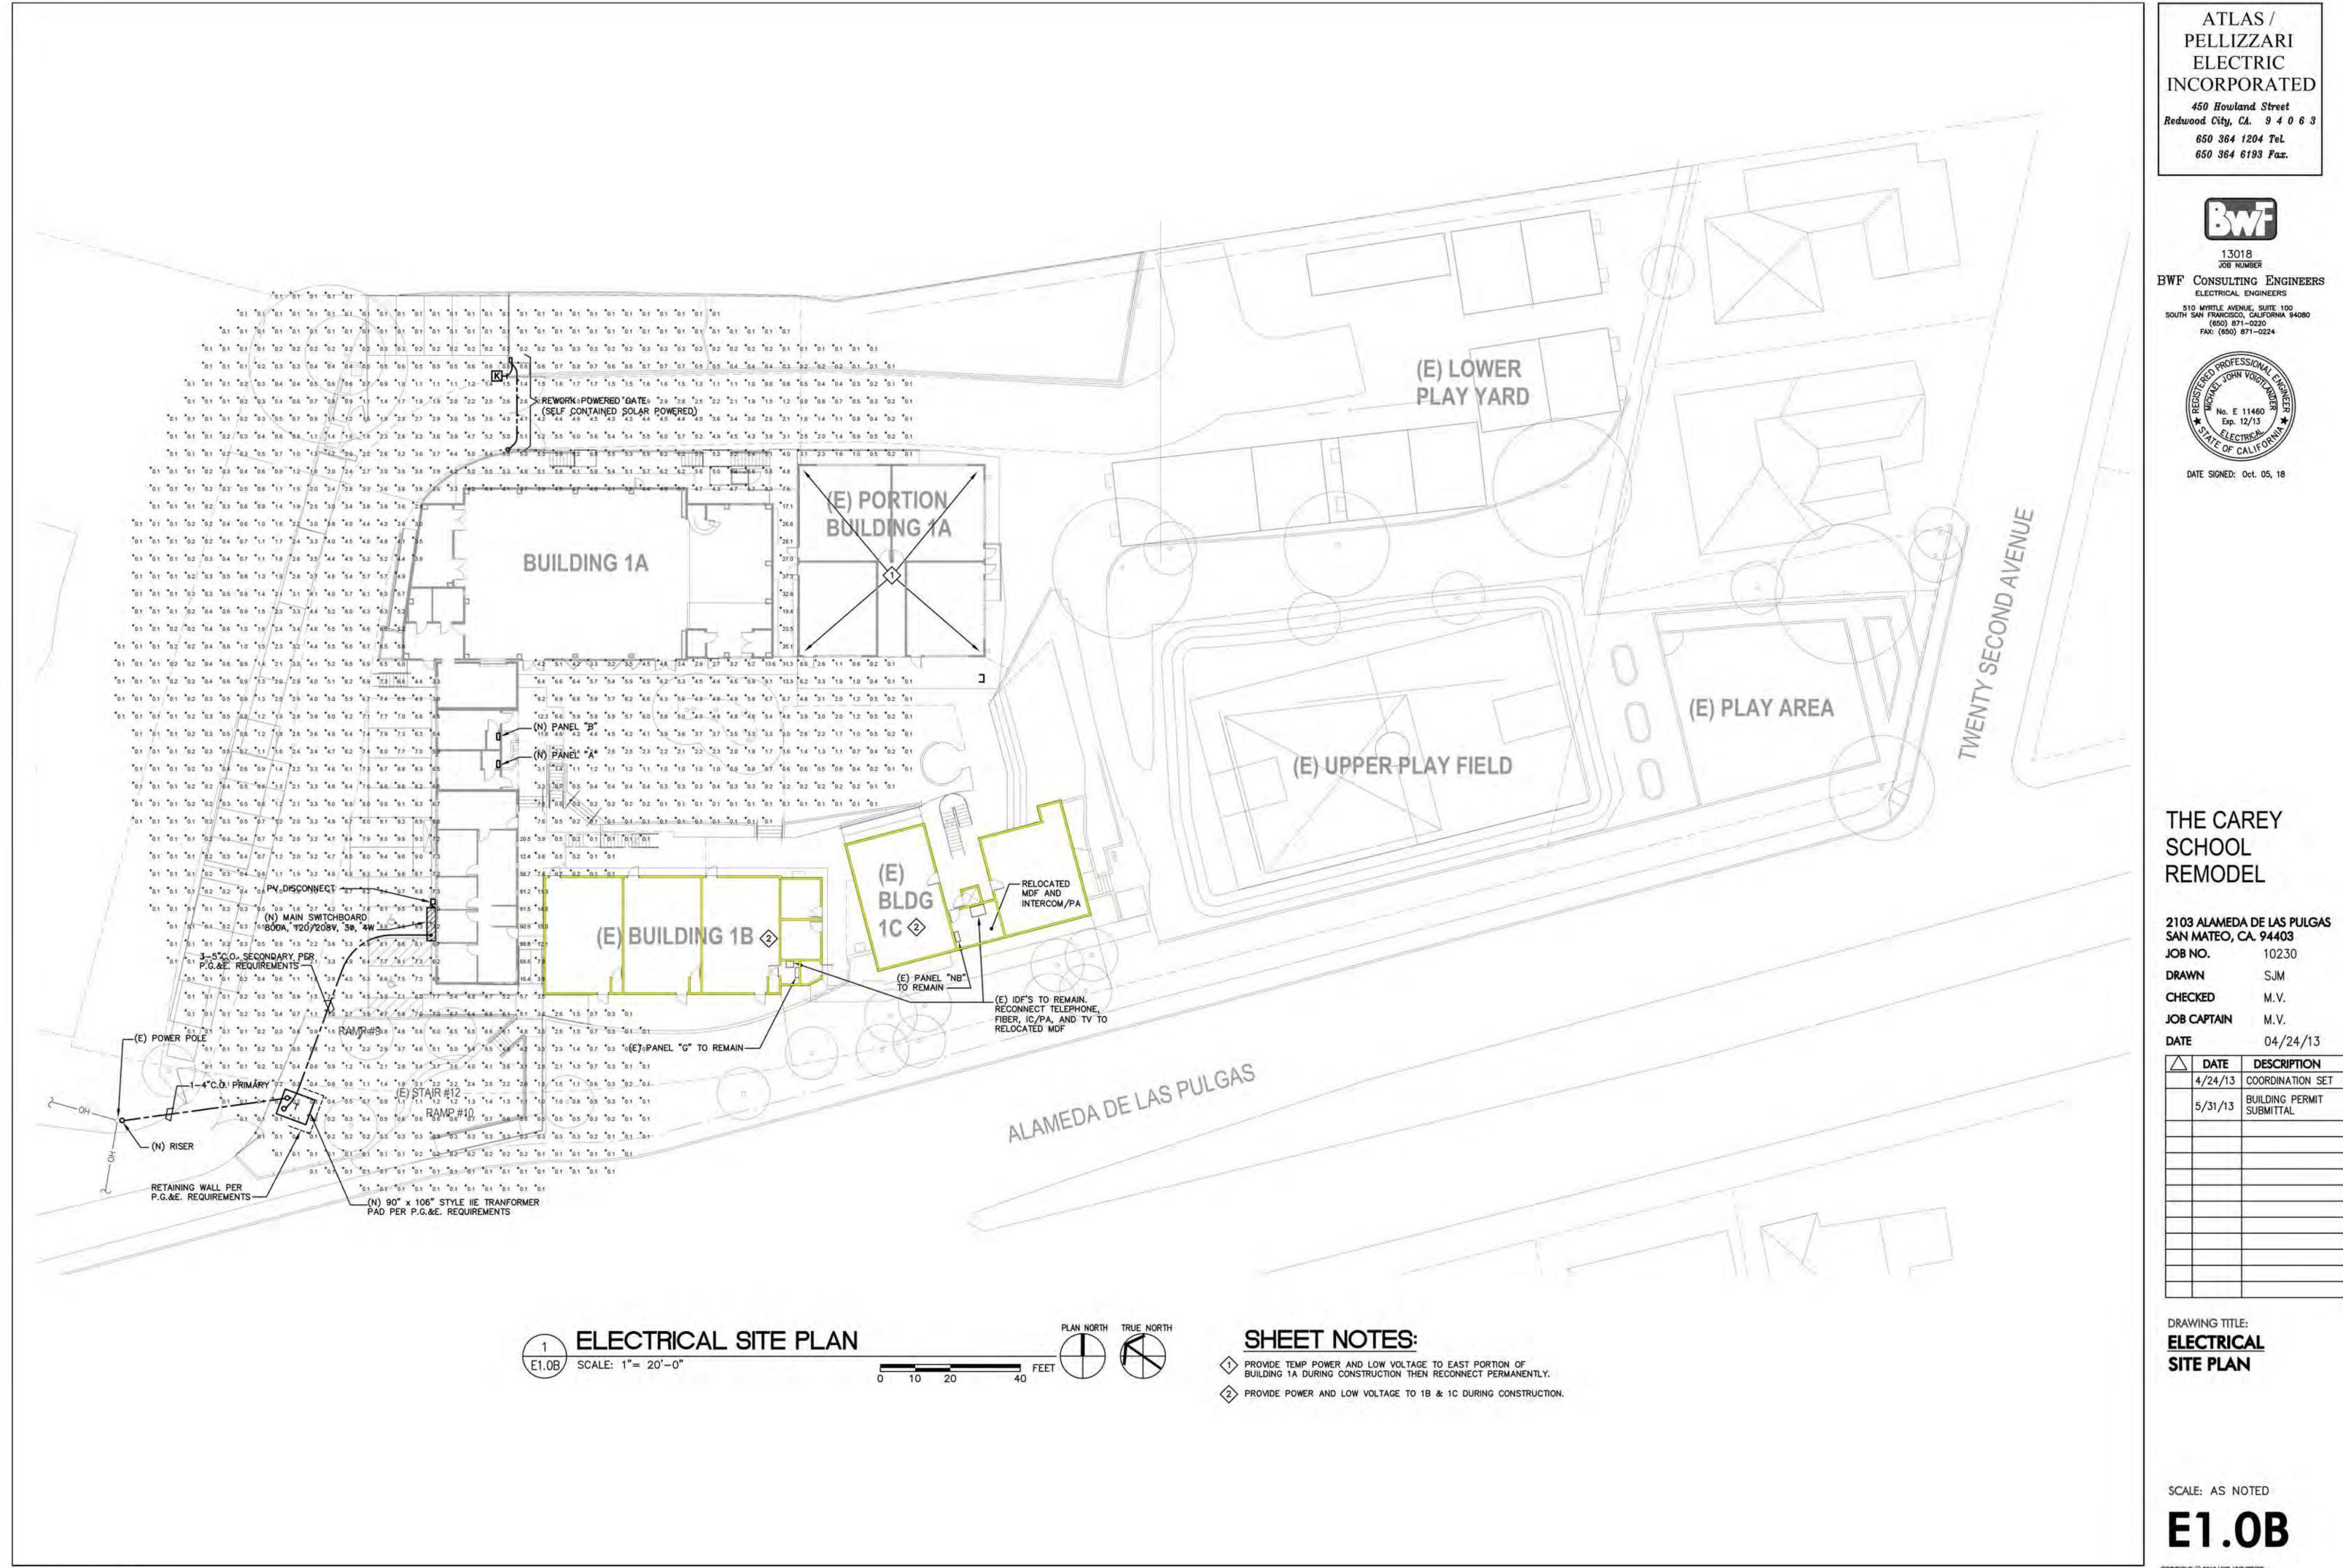
JOB NO. DRAWN

M.V. CHECKED JOB CAPTAIN M.V.


ISS	UE	
	DATE	DESCRIPTION
	11-16-18	100% SCHEMATIC DESIGN
	01-30-19	PLANNING RESUBMITTAL

DRAWING TITLE ELECTRICAL SECOND FLOOR LIGHTING PLAN

SCALE AS NOTED



		01/21/10	
\triangle	DATE	DESCRIPTION	
	4/24/13	COORDINATION SET	
	5/31/13	BUILDING PERMIT SUBMITTAL	

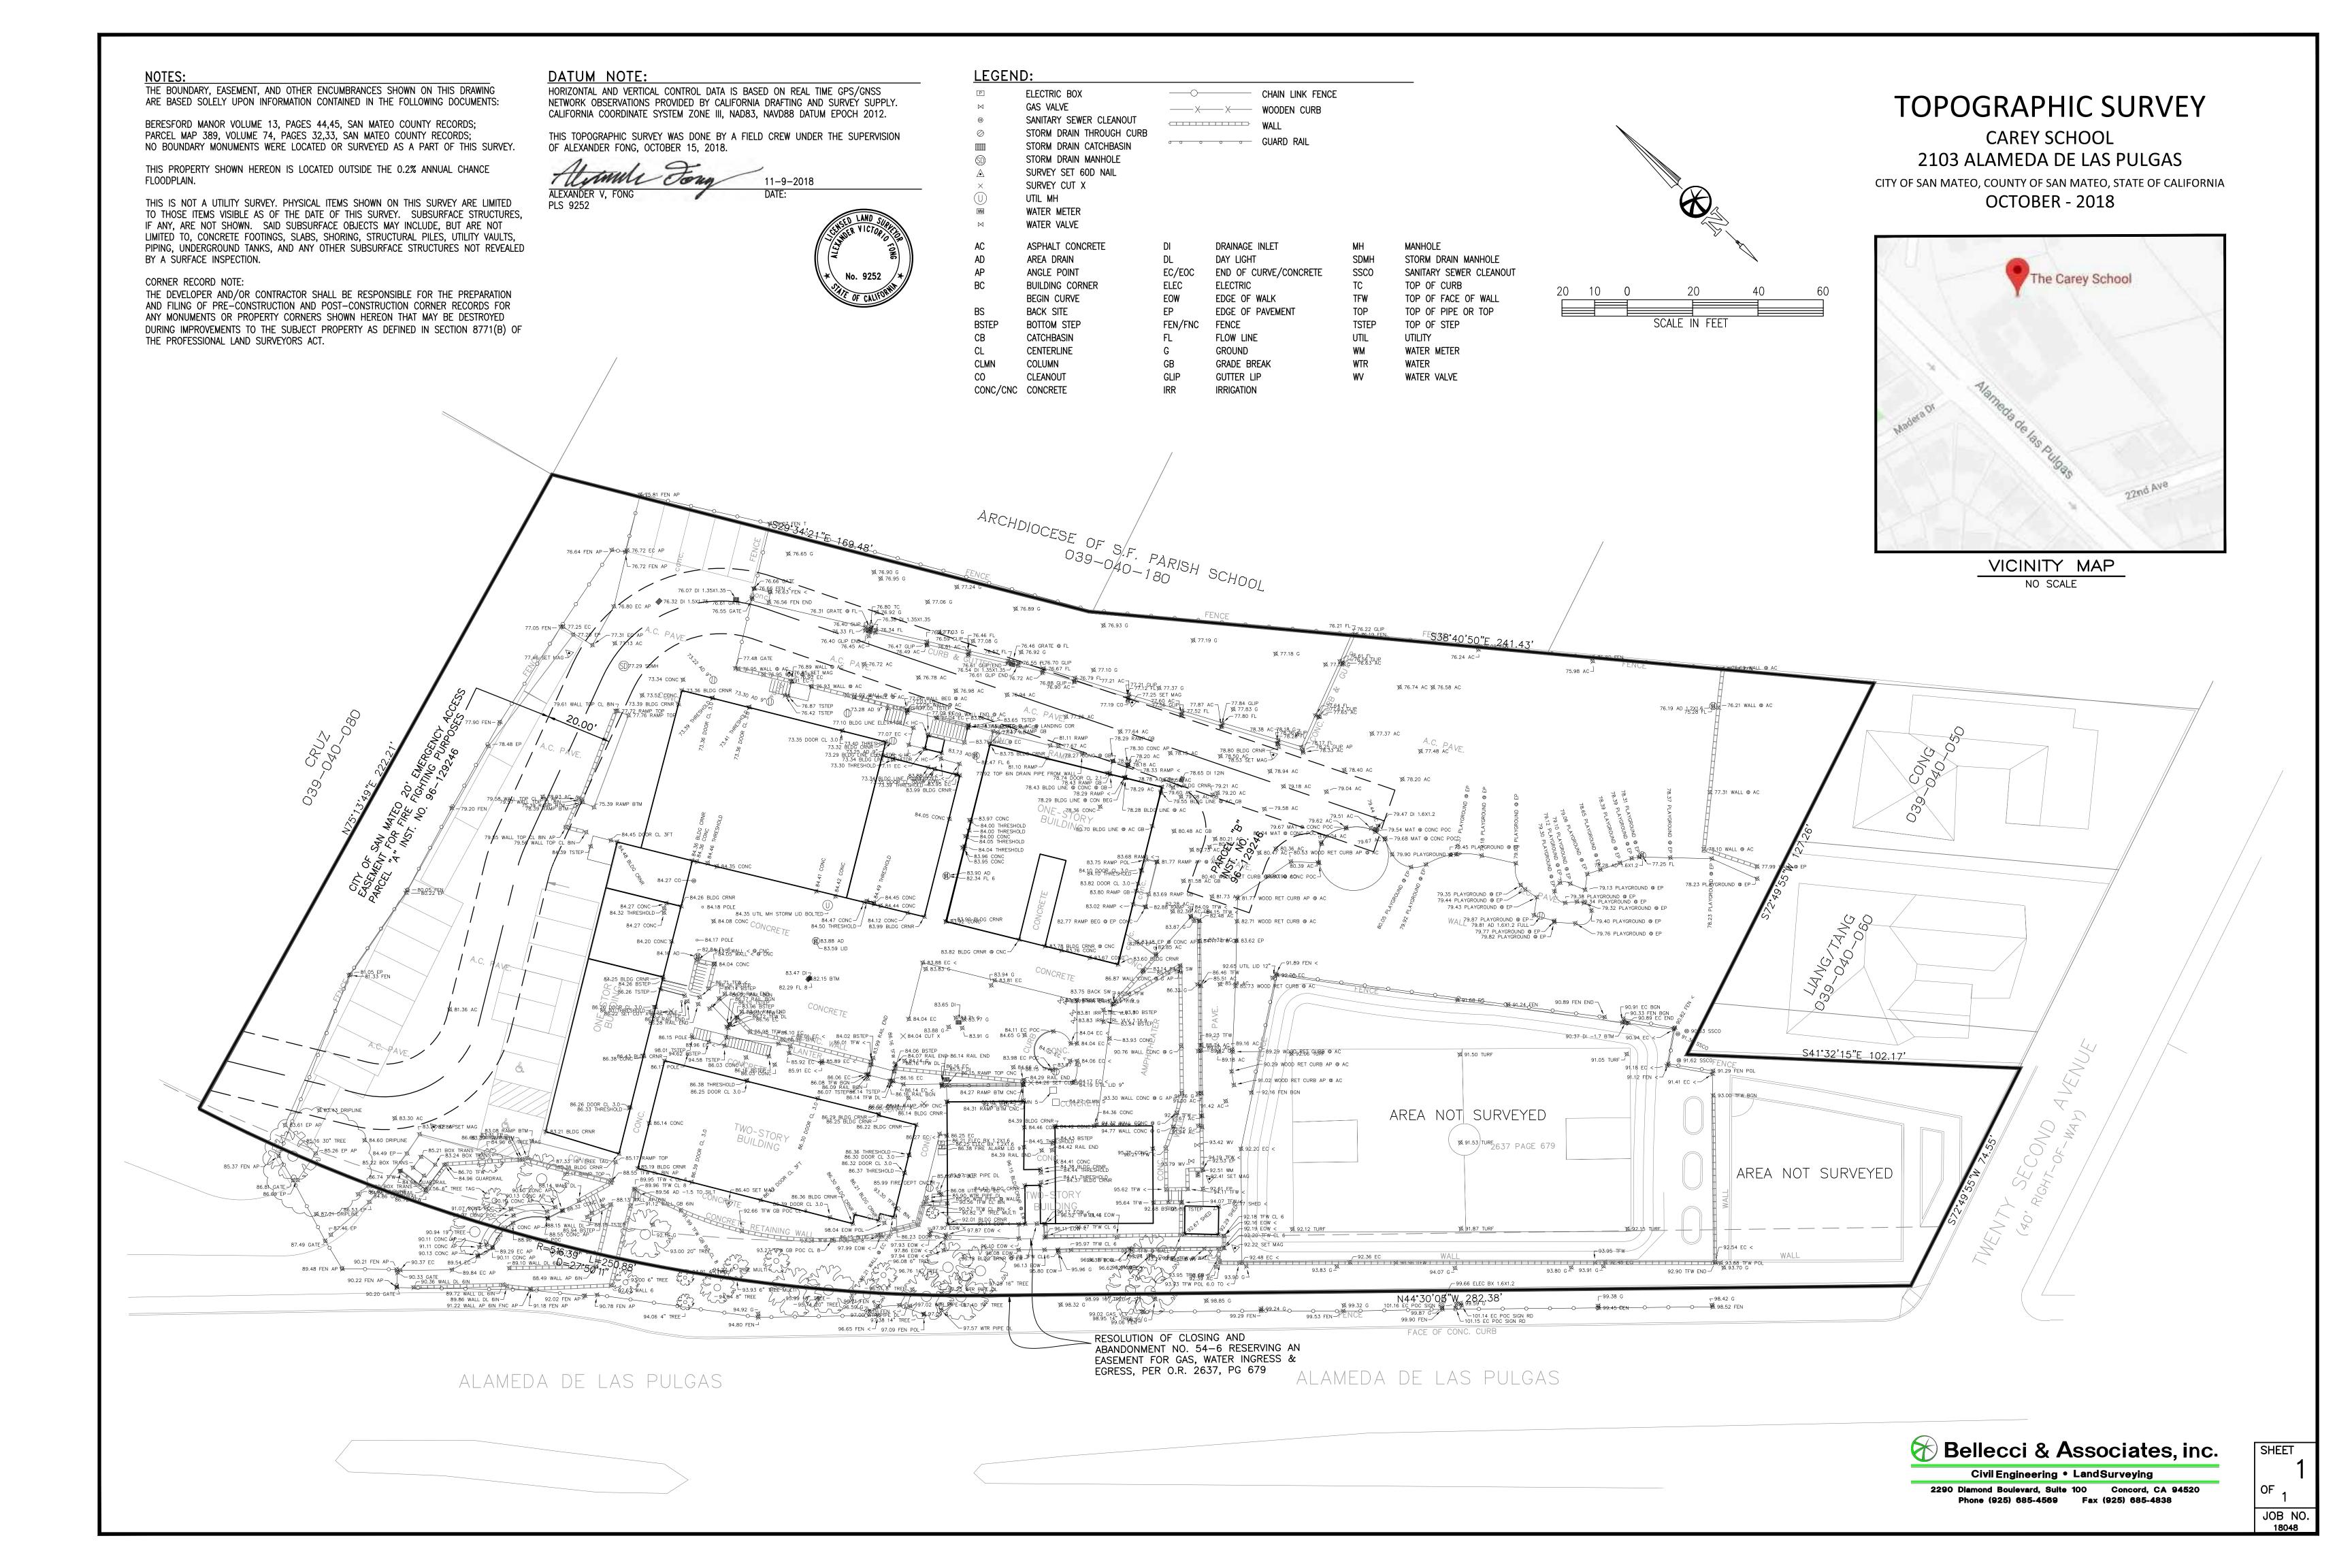

1 ARCHITECTS

HKITAF

INSTRUCTION Management • Land Surve

ROBERT E BROESTL
No. 41828

CIVIL
OF CAL FORMER

THE CAREY SCHOOL ADDITION & COURTYARD REMODEL

2103 ALAMEDA DE LAS PULGAS SAN MATEO, CA 94403

JOB NO. 10232 DRAWN KC

CHECKED RB


JOB CAPTAIN JAS

ISSUE		
DESCRIPTION		
100% SD/ PLANNING SUBMITTAL		
PLANNING RESUBMITTAL		

DEMOLITION PLAN

Call Two Working Days Before You Dig!

SCALE As indicated

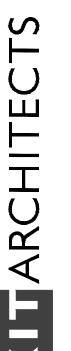

THE CAREY SCHOOL **ADDITION &** COURTYARD

REMODEL 2103 ALAMEDA DE LAS PULGAS SAN MATEO, CA 94403 JOB NO.

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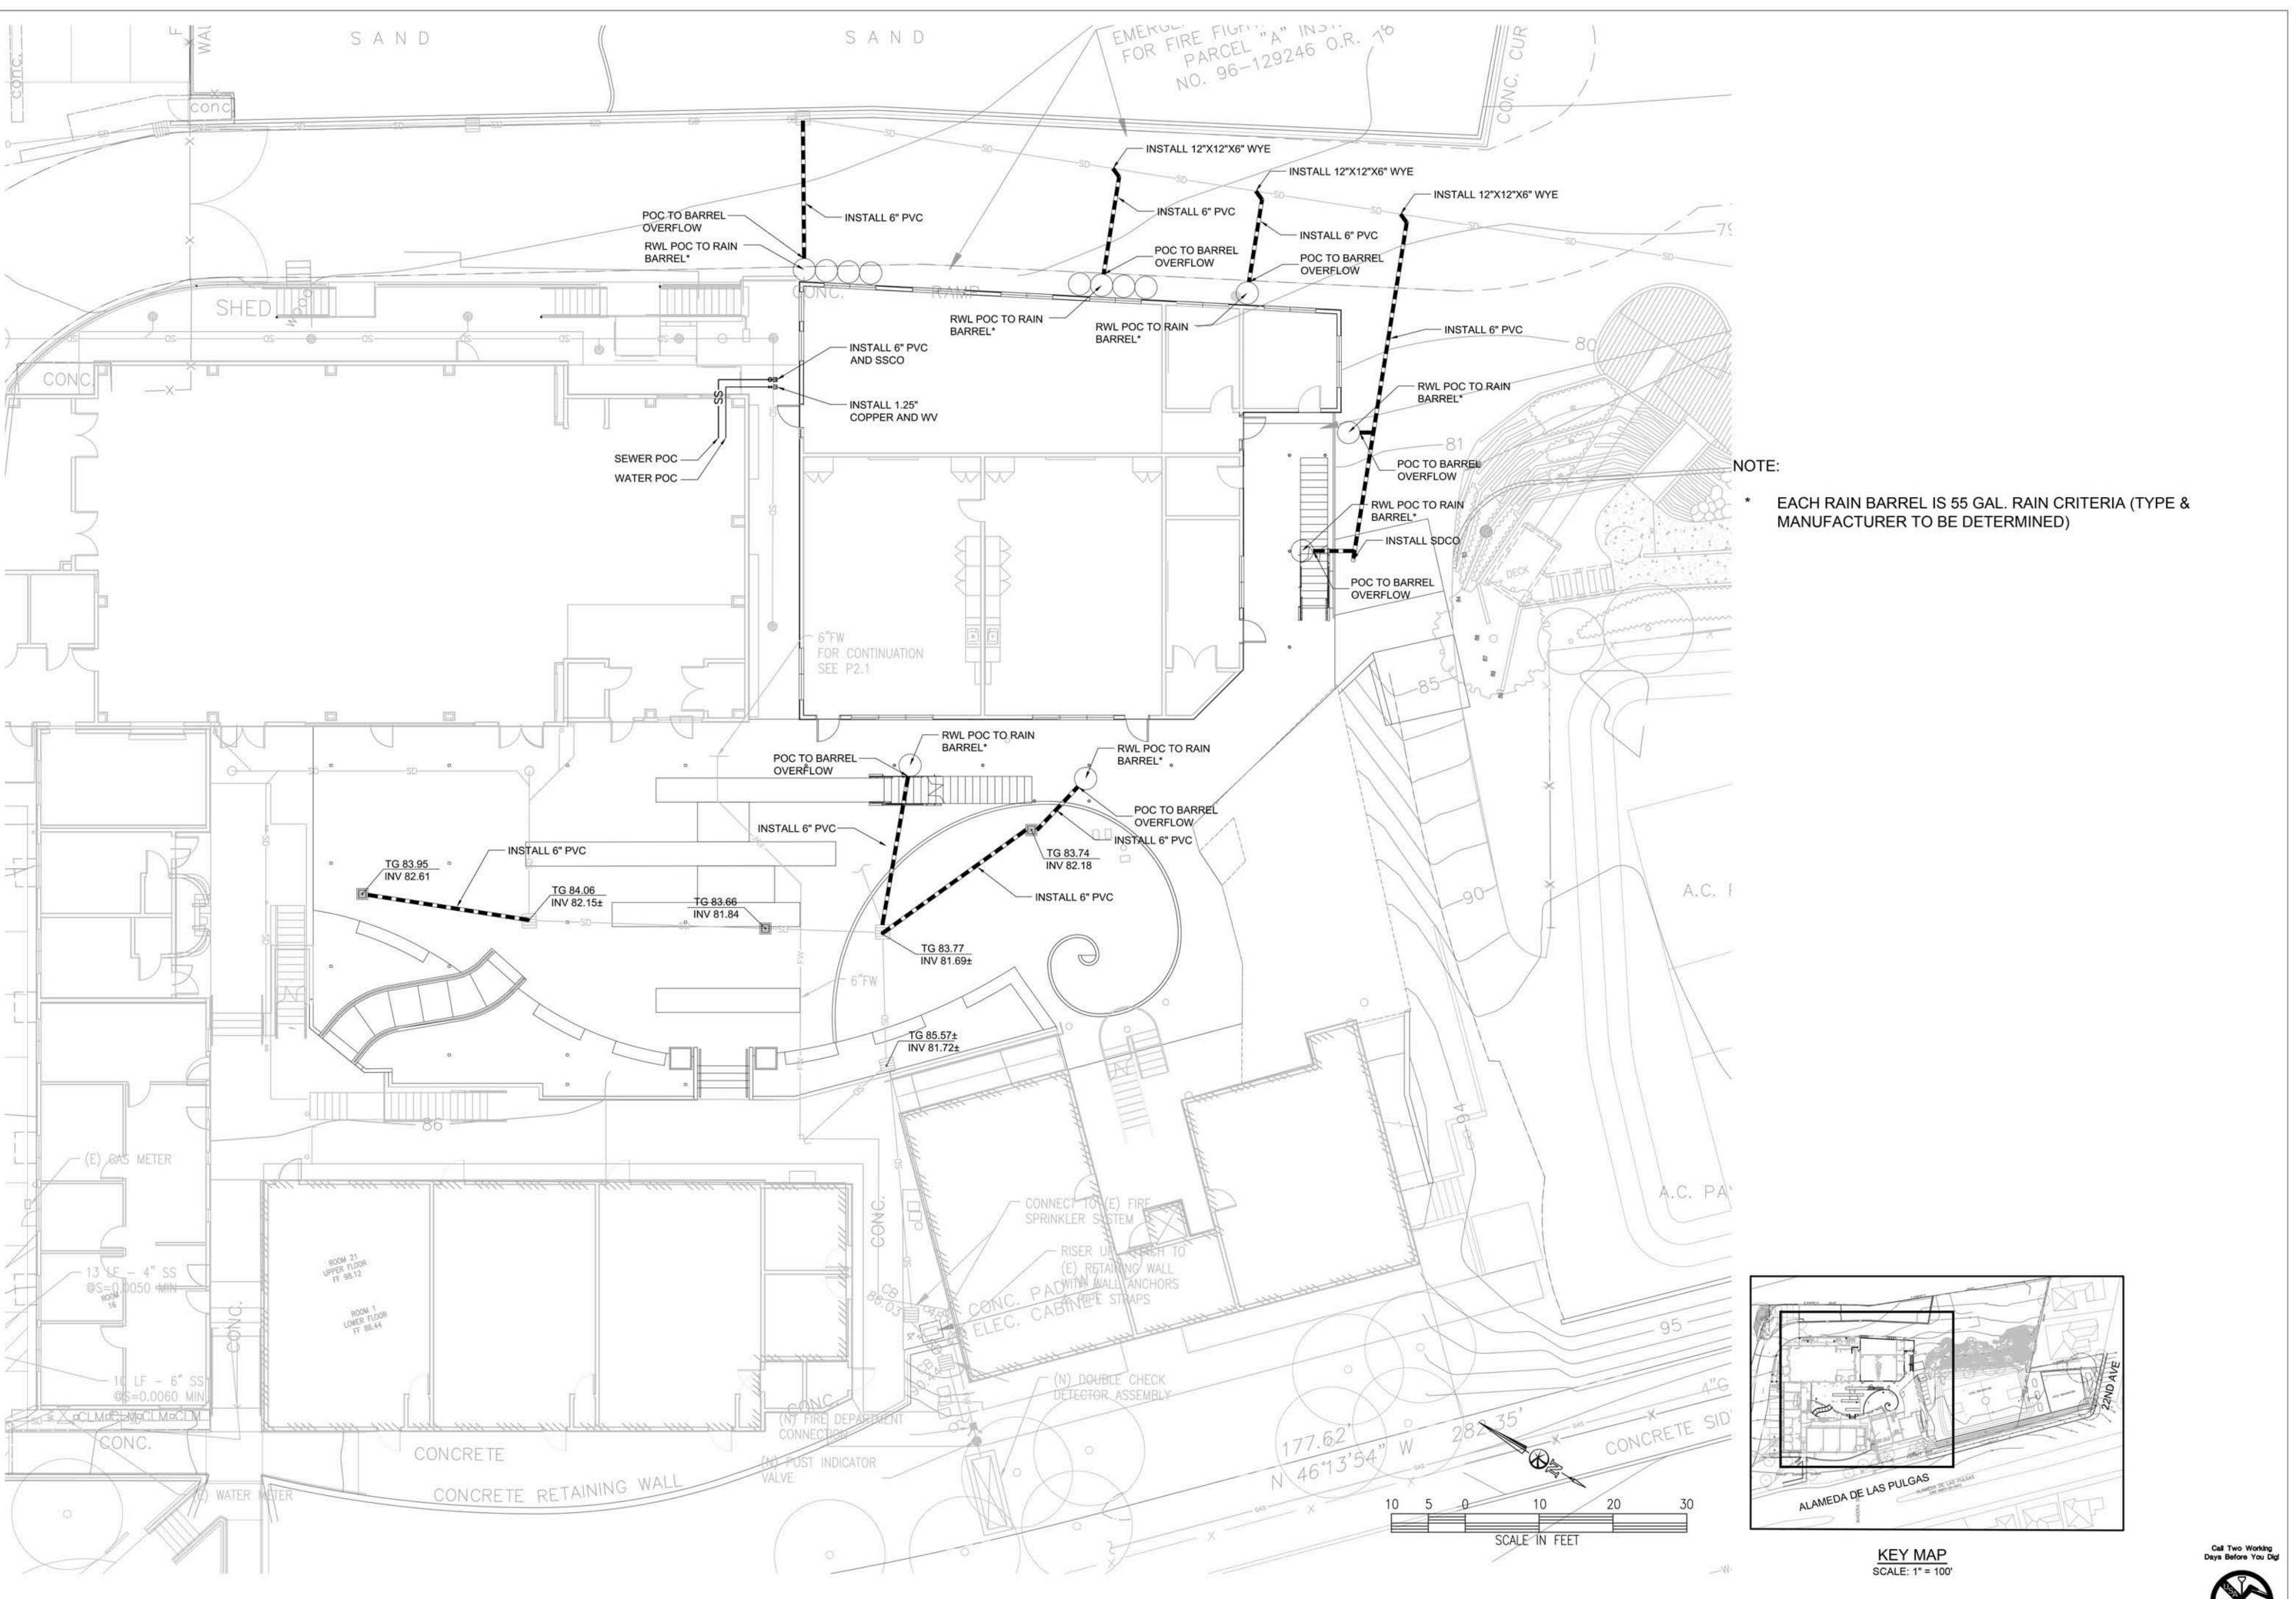
JOB CAPTAIN

ISSUE DESCRIPTION DATE 100% SD/ PLANNING SUBMITTAL PLANNING RESUBMITTAL

DRAWING TITLE **GRADING PLAN**

Call Two Working Days Before You Dig!

SCALE As indicated



THE CAREY **SCHOOL ADDITION &** COURTYARD REMODEL


2103 ALAMEDA DE LAS PULGAS SAN MATEO, CA 94403 10232 JOB NO.

DRAWN CHECKED

JOB CAPTAIN

DATE	DESCRIPTION
NOV. 16, 2018	100% SD/ PLANNING SUBMITTAL
JAN. 30, 2019	PLANNING RESUBMITTAL
FEB. 19, 2019	PLANNING RESUBMITTAL R
	
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DRAWING TITLE **UTILITY PLAN**

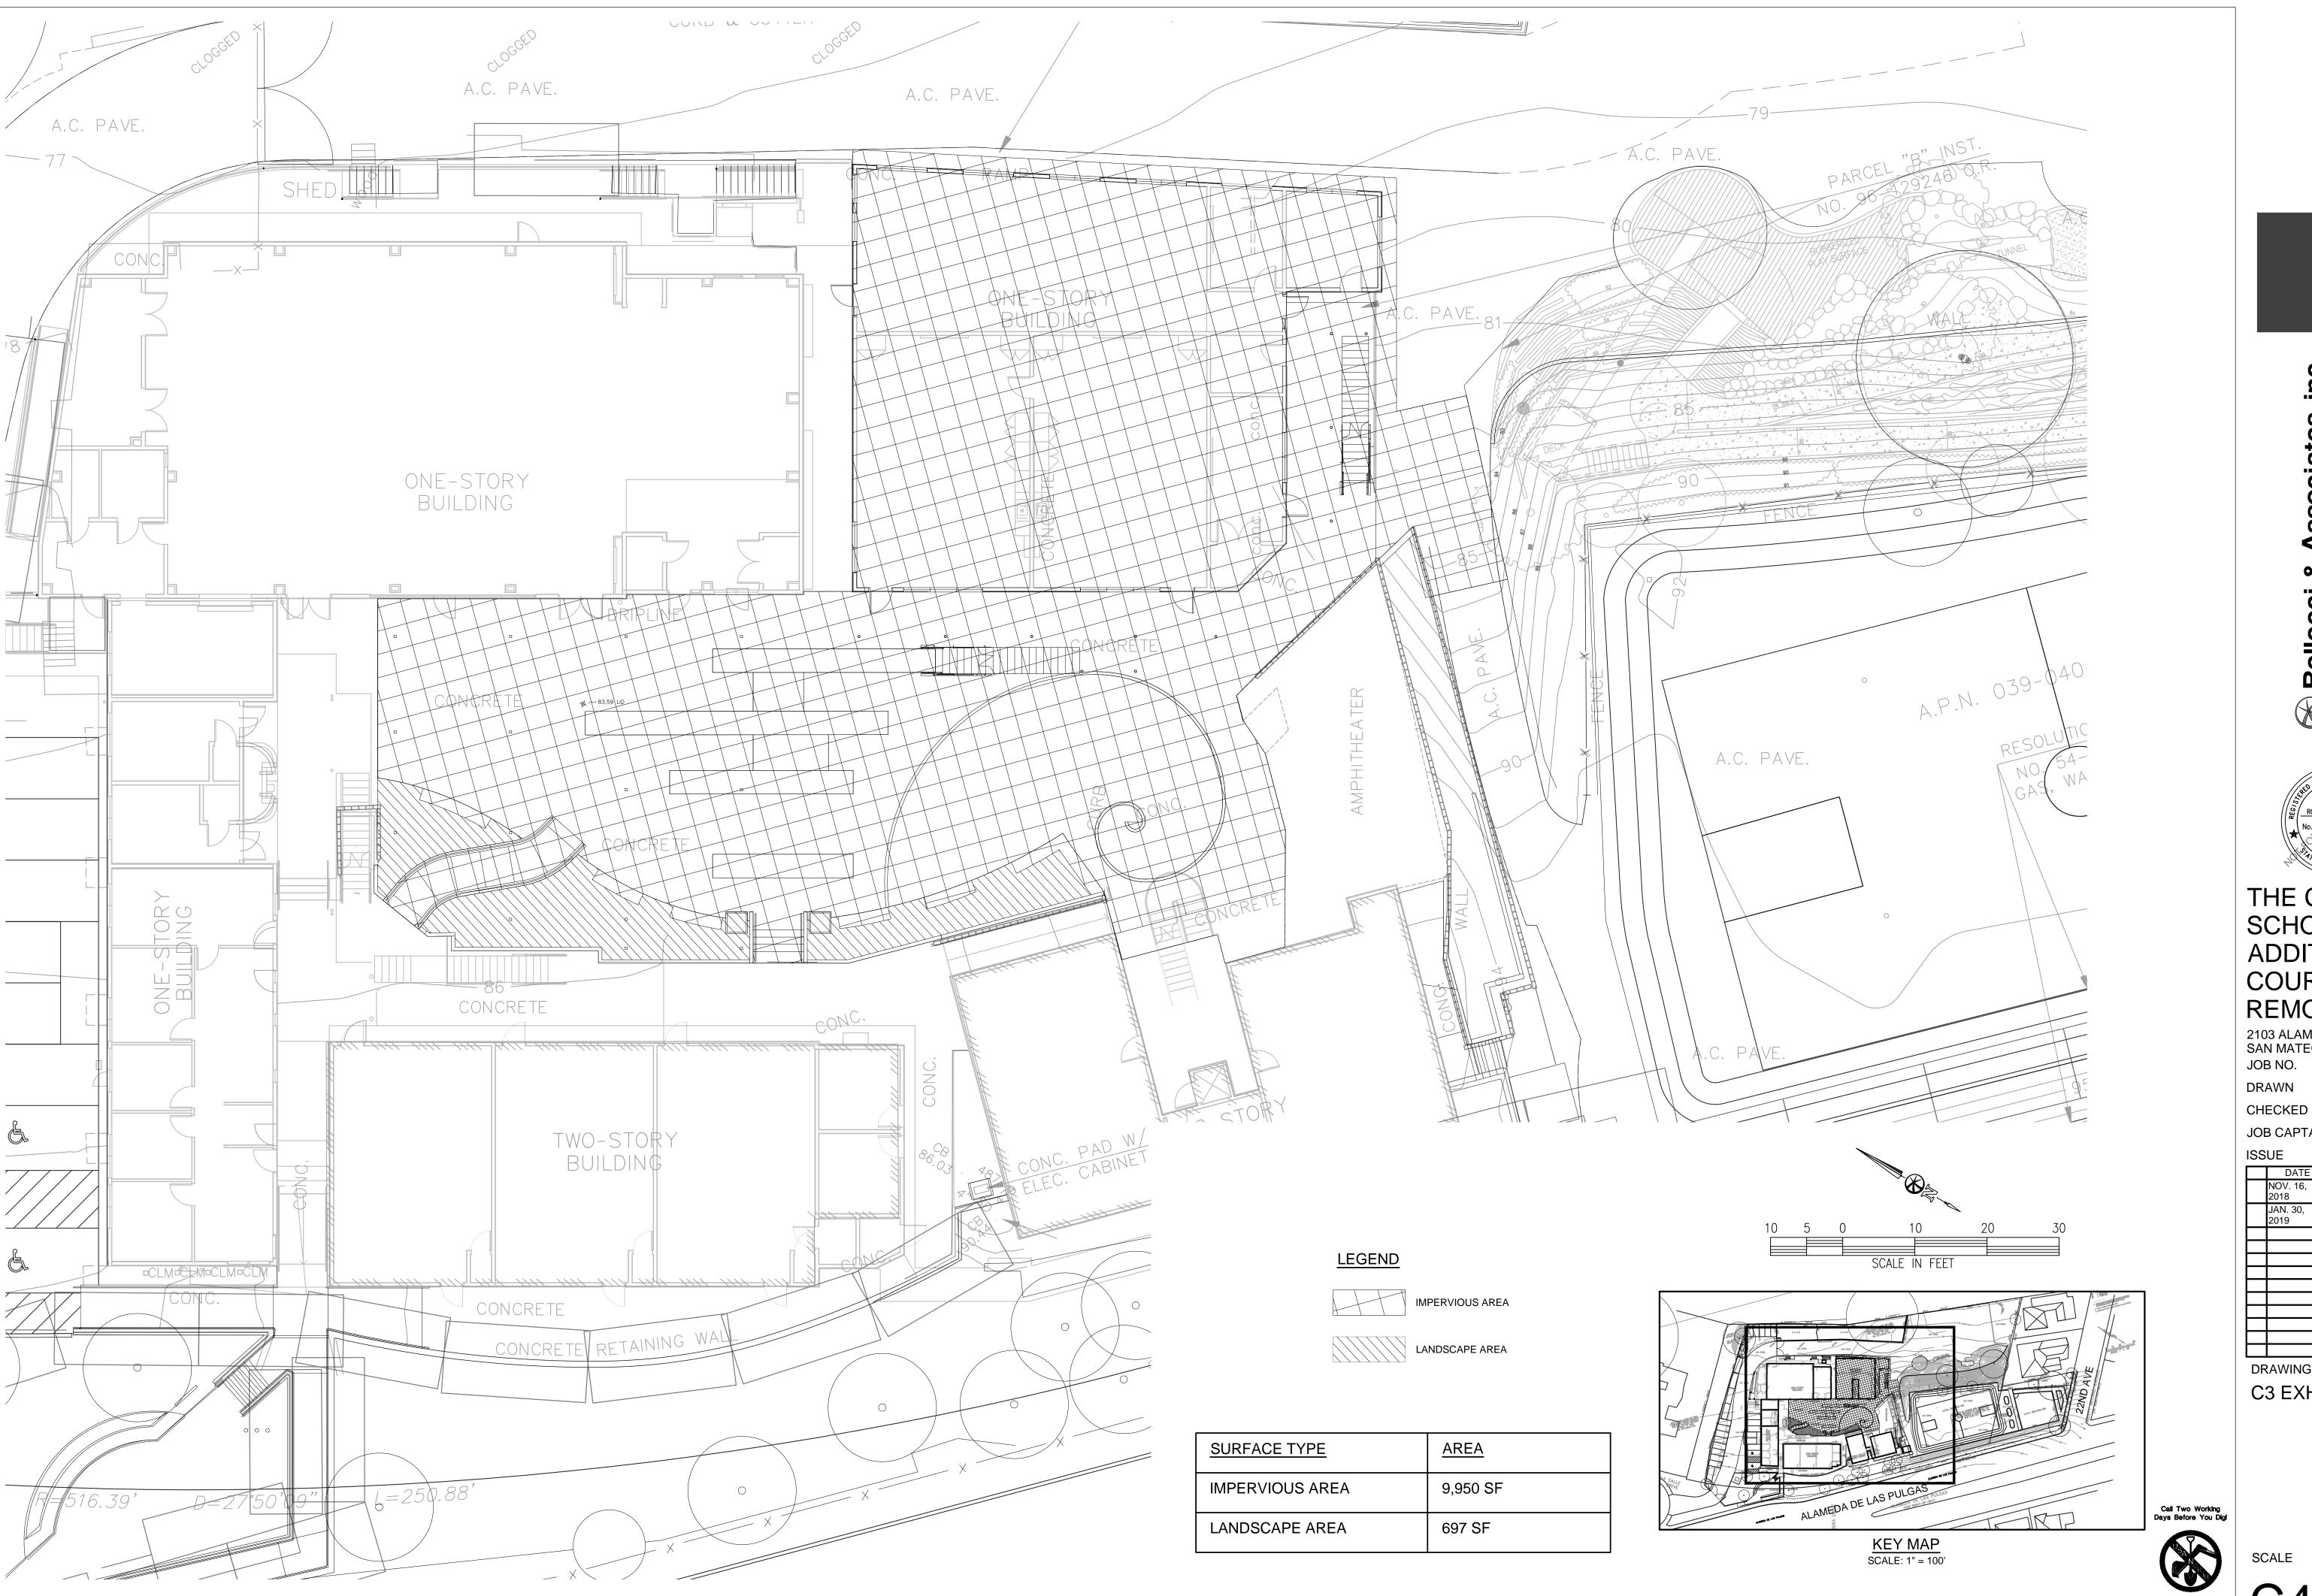

THE CAREY SCHOOL **ADDITION &**


COURTYARD REMODEL 2103 ALAMEDA DE LAS PULGAS SAN MATEO, CA 94403


10232


JOB CAPTAIN

DATE DESCRIPTION 100% SD/ PLANNING SUBMITTAL PLANNING RESUBMITTAL

DRAWING TITLE C3 EXHIBIT

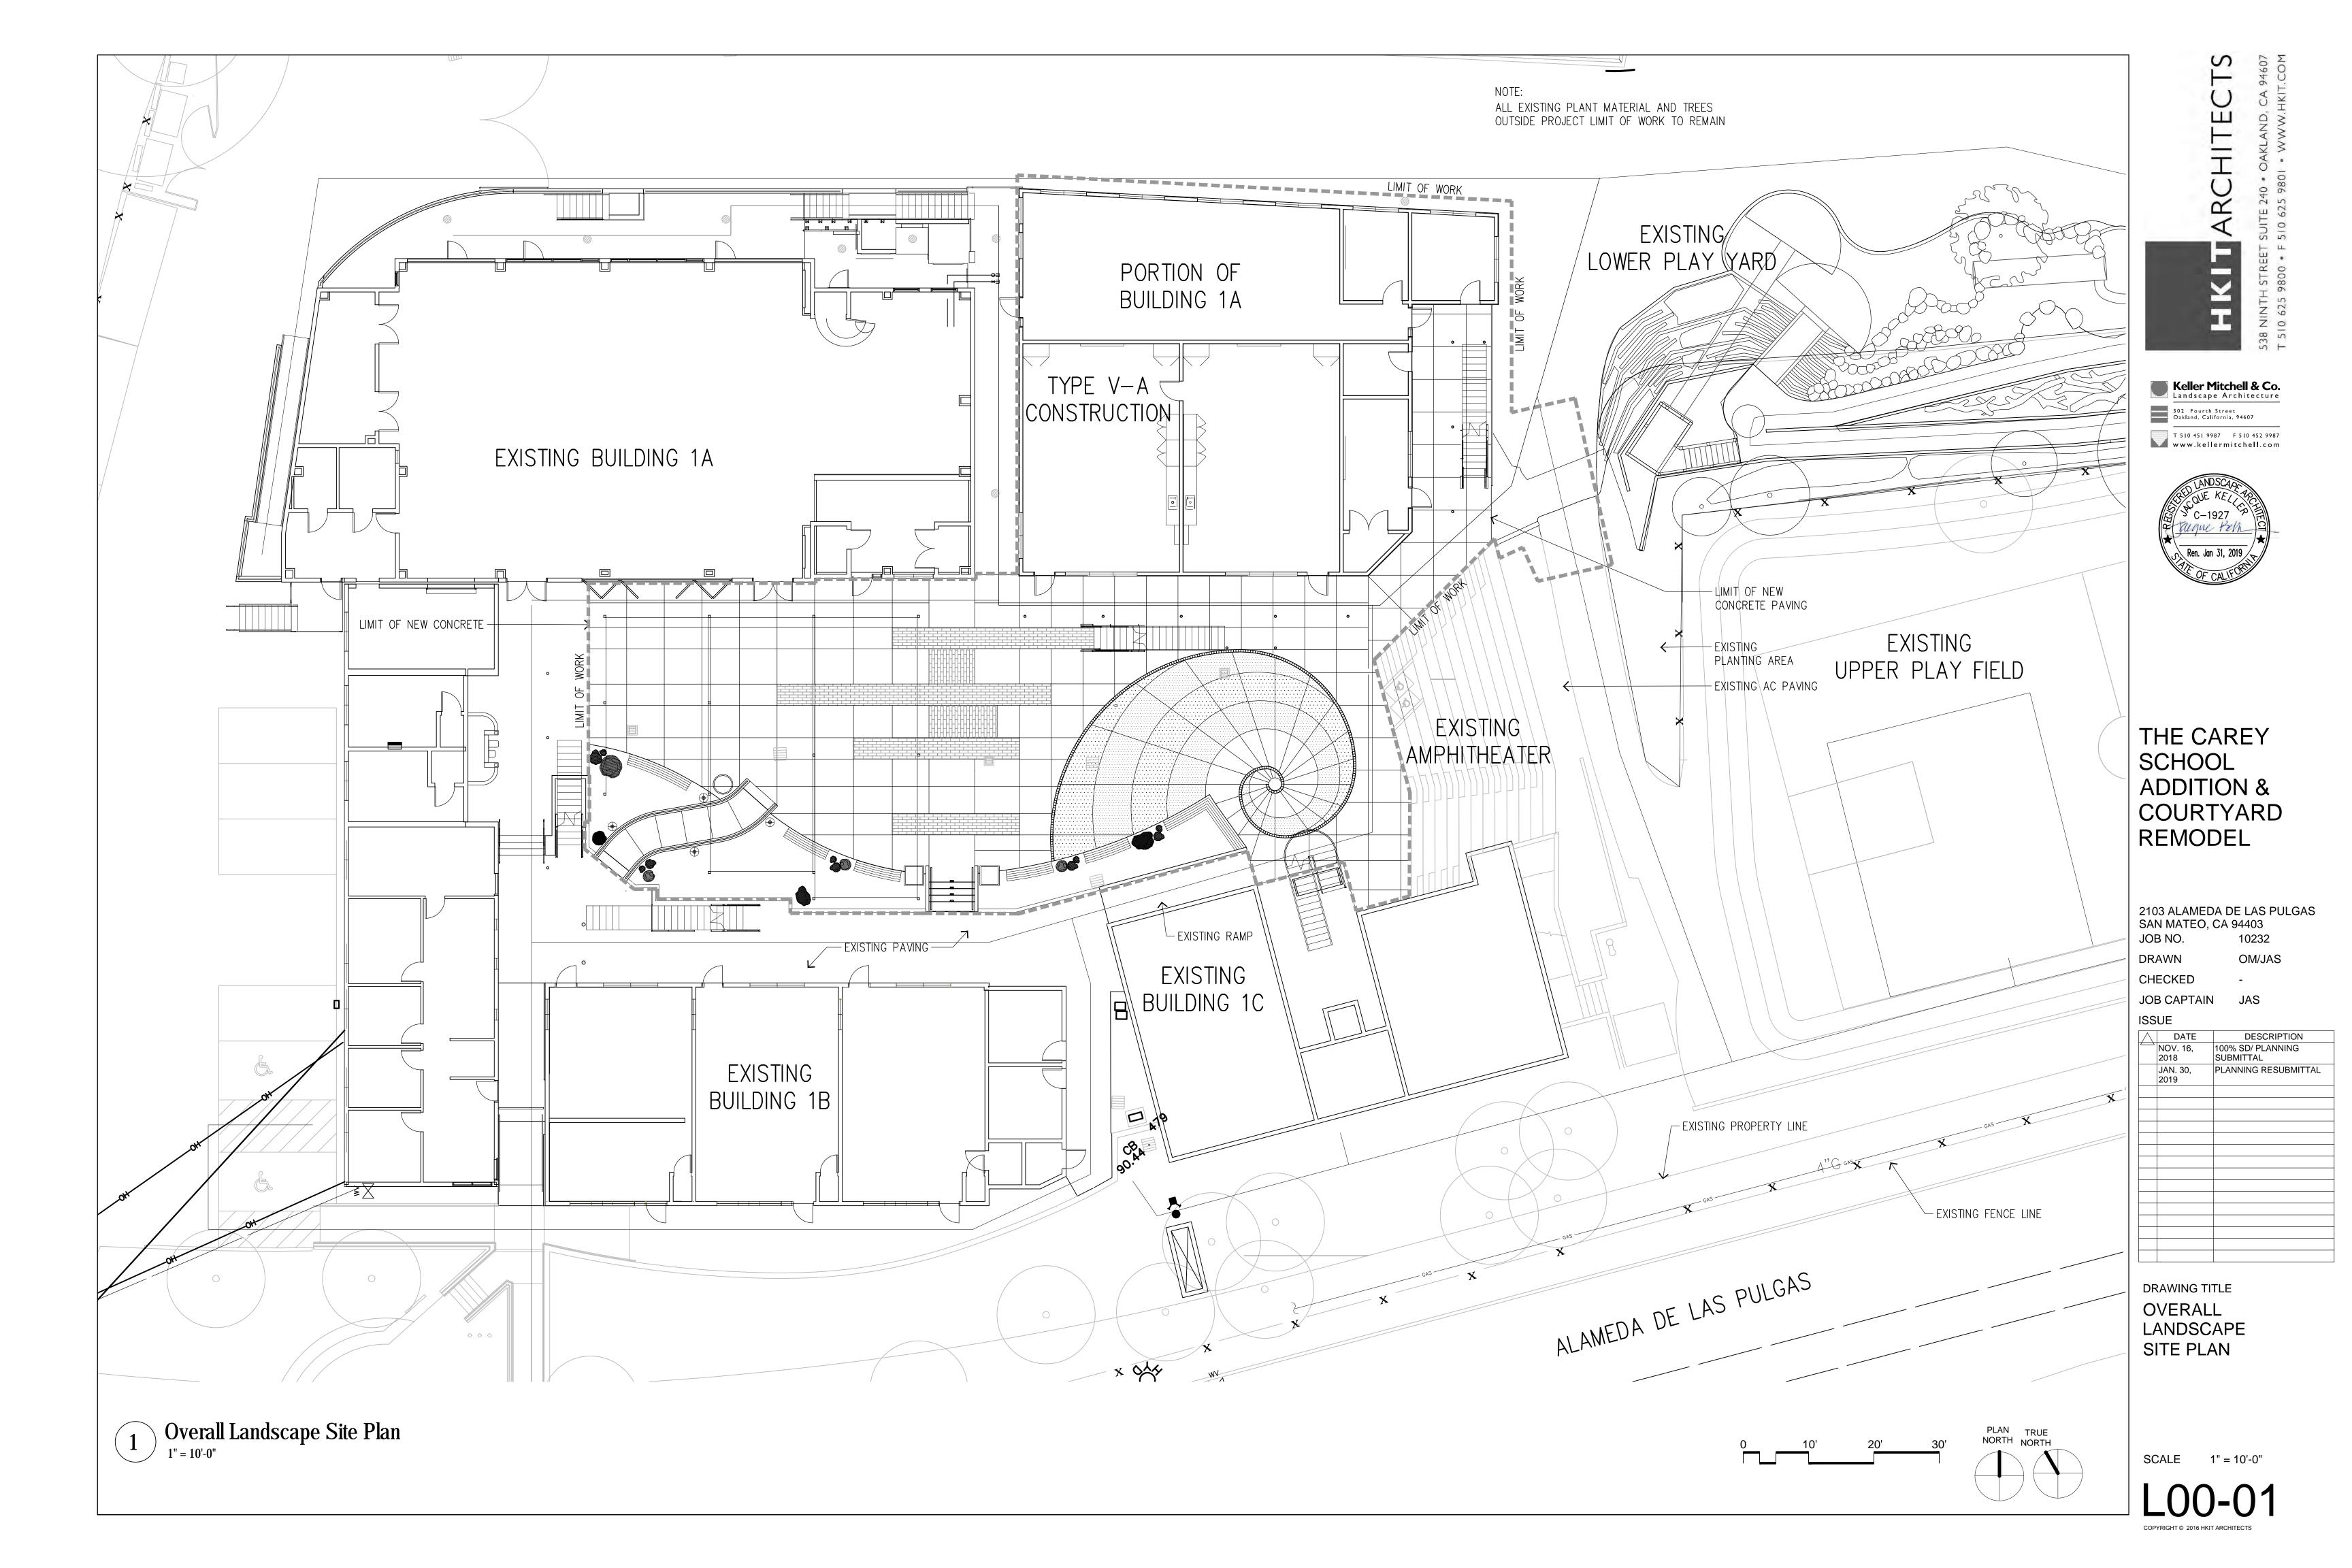

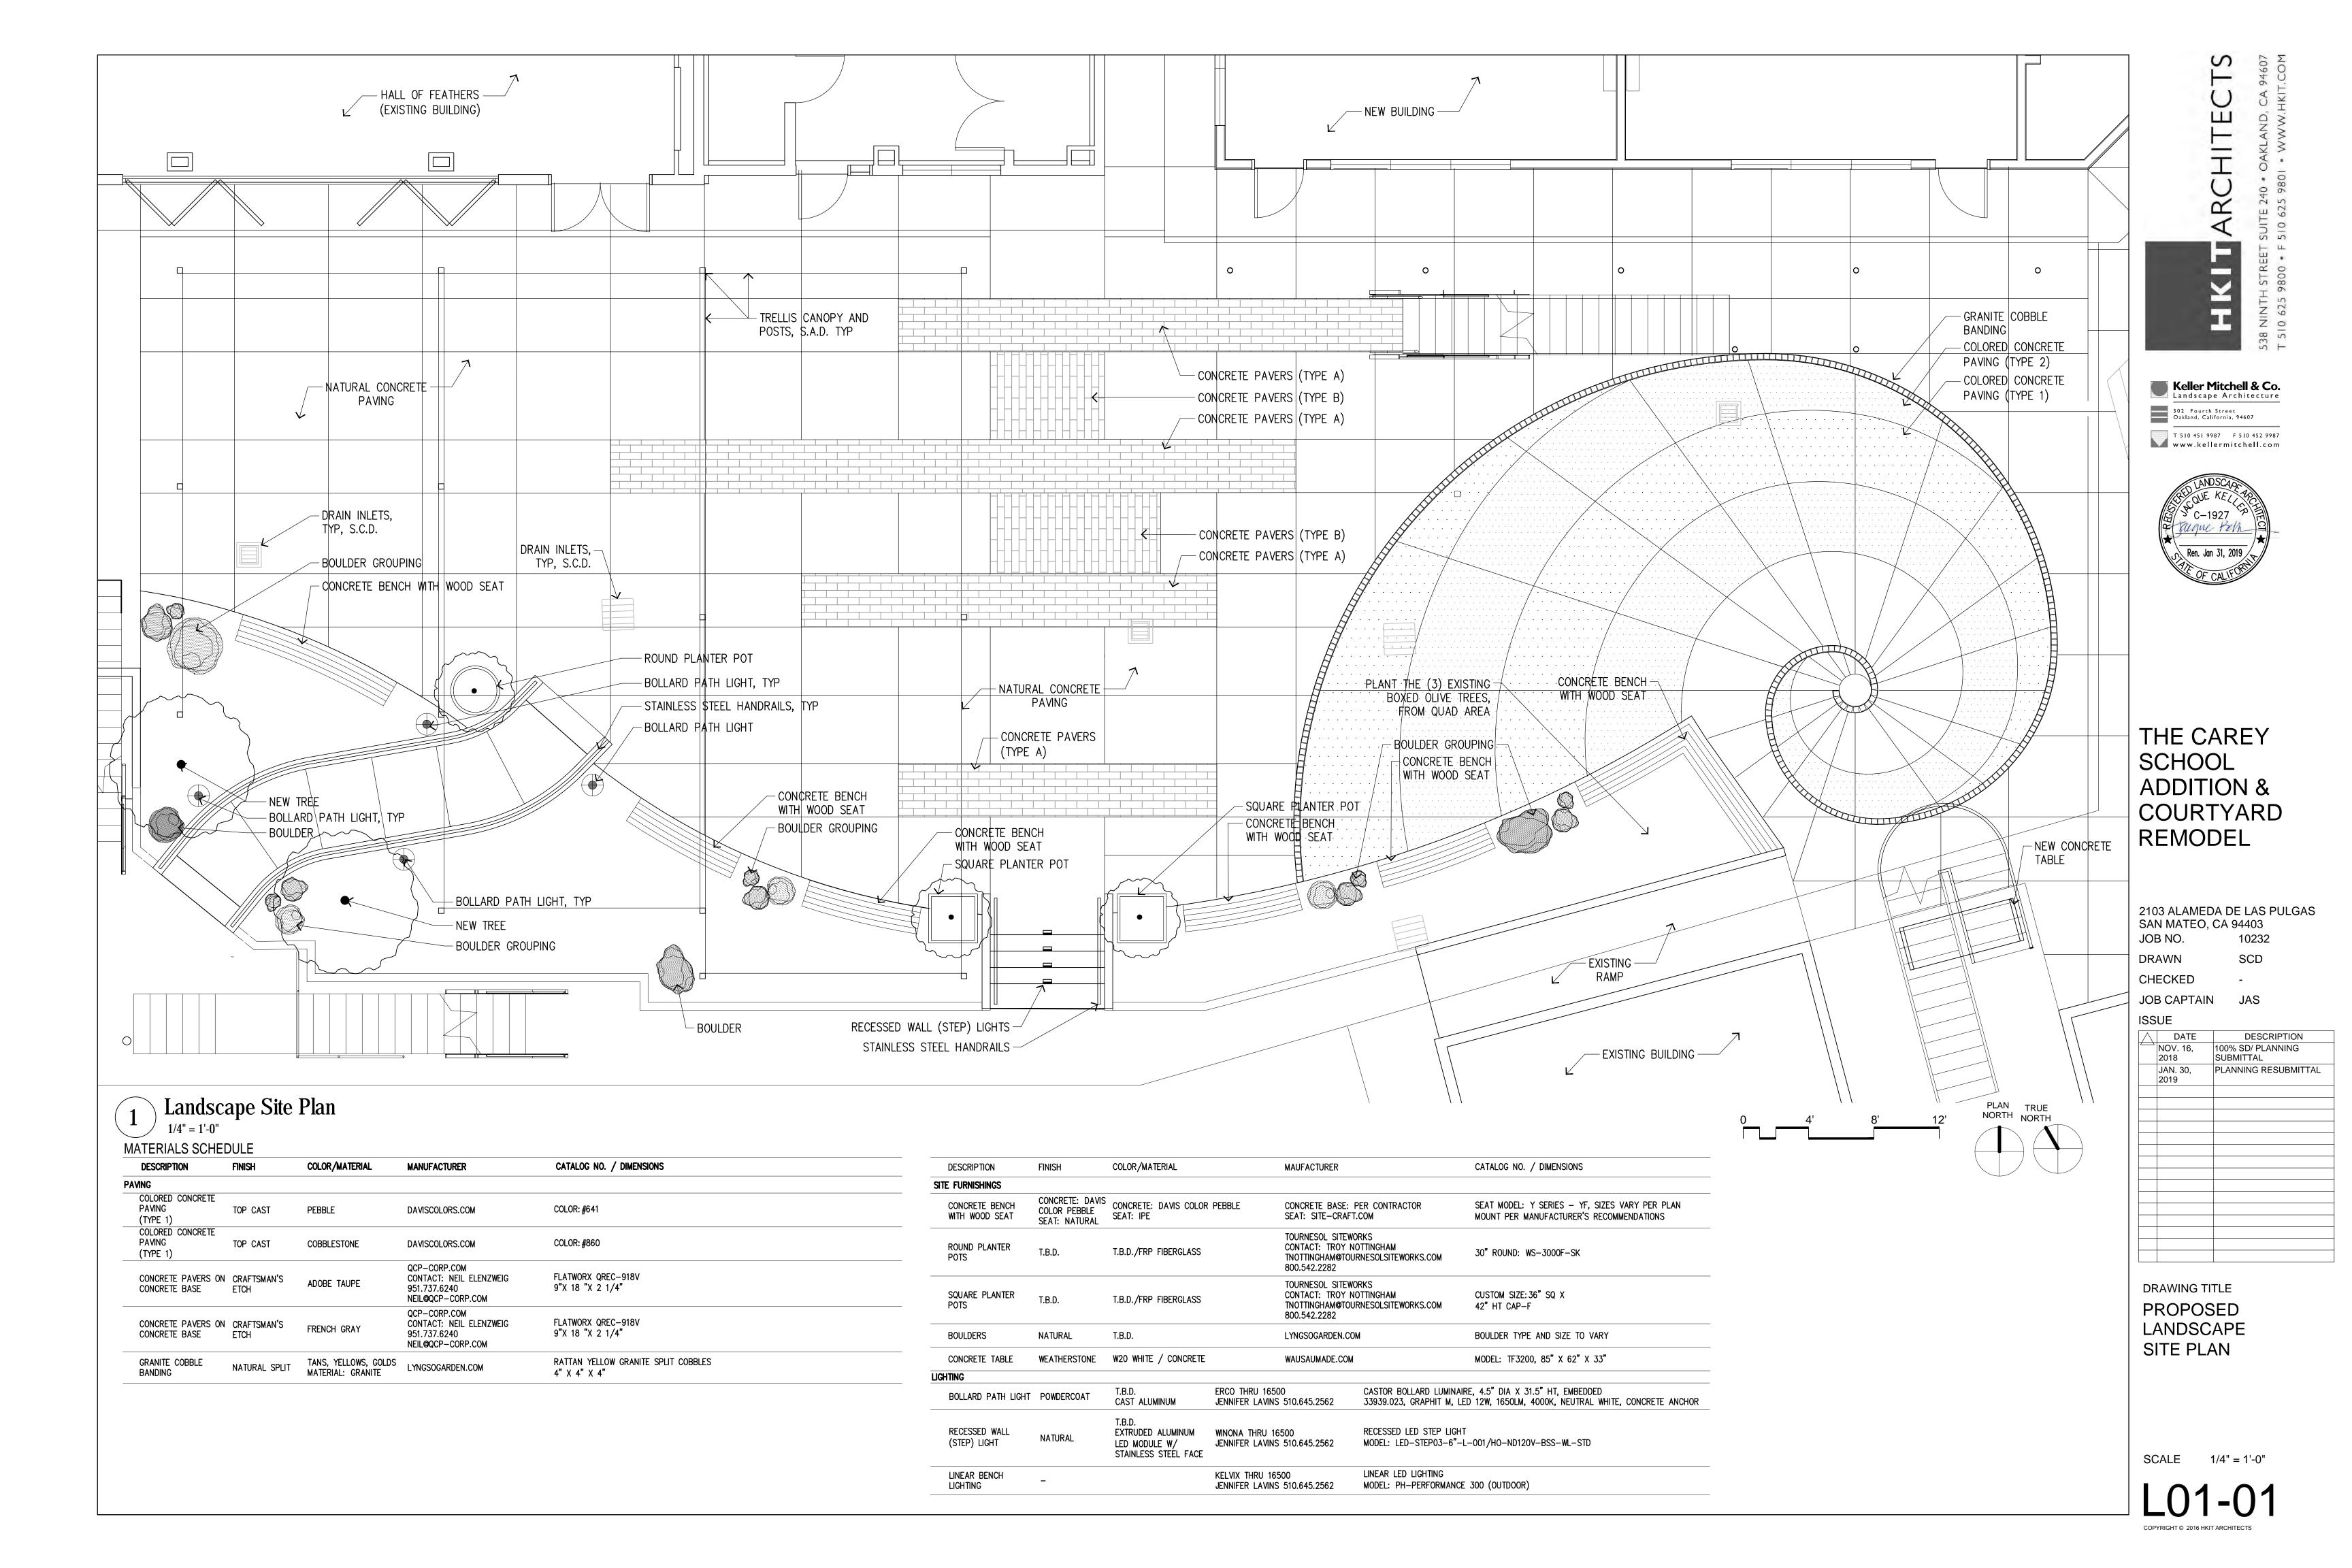

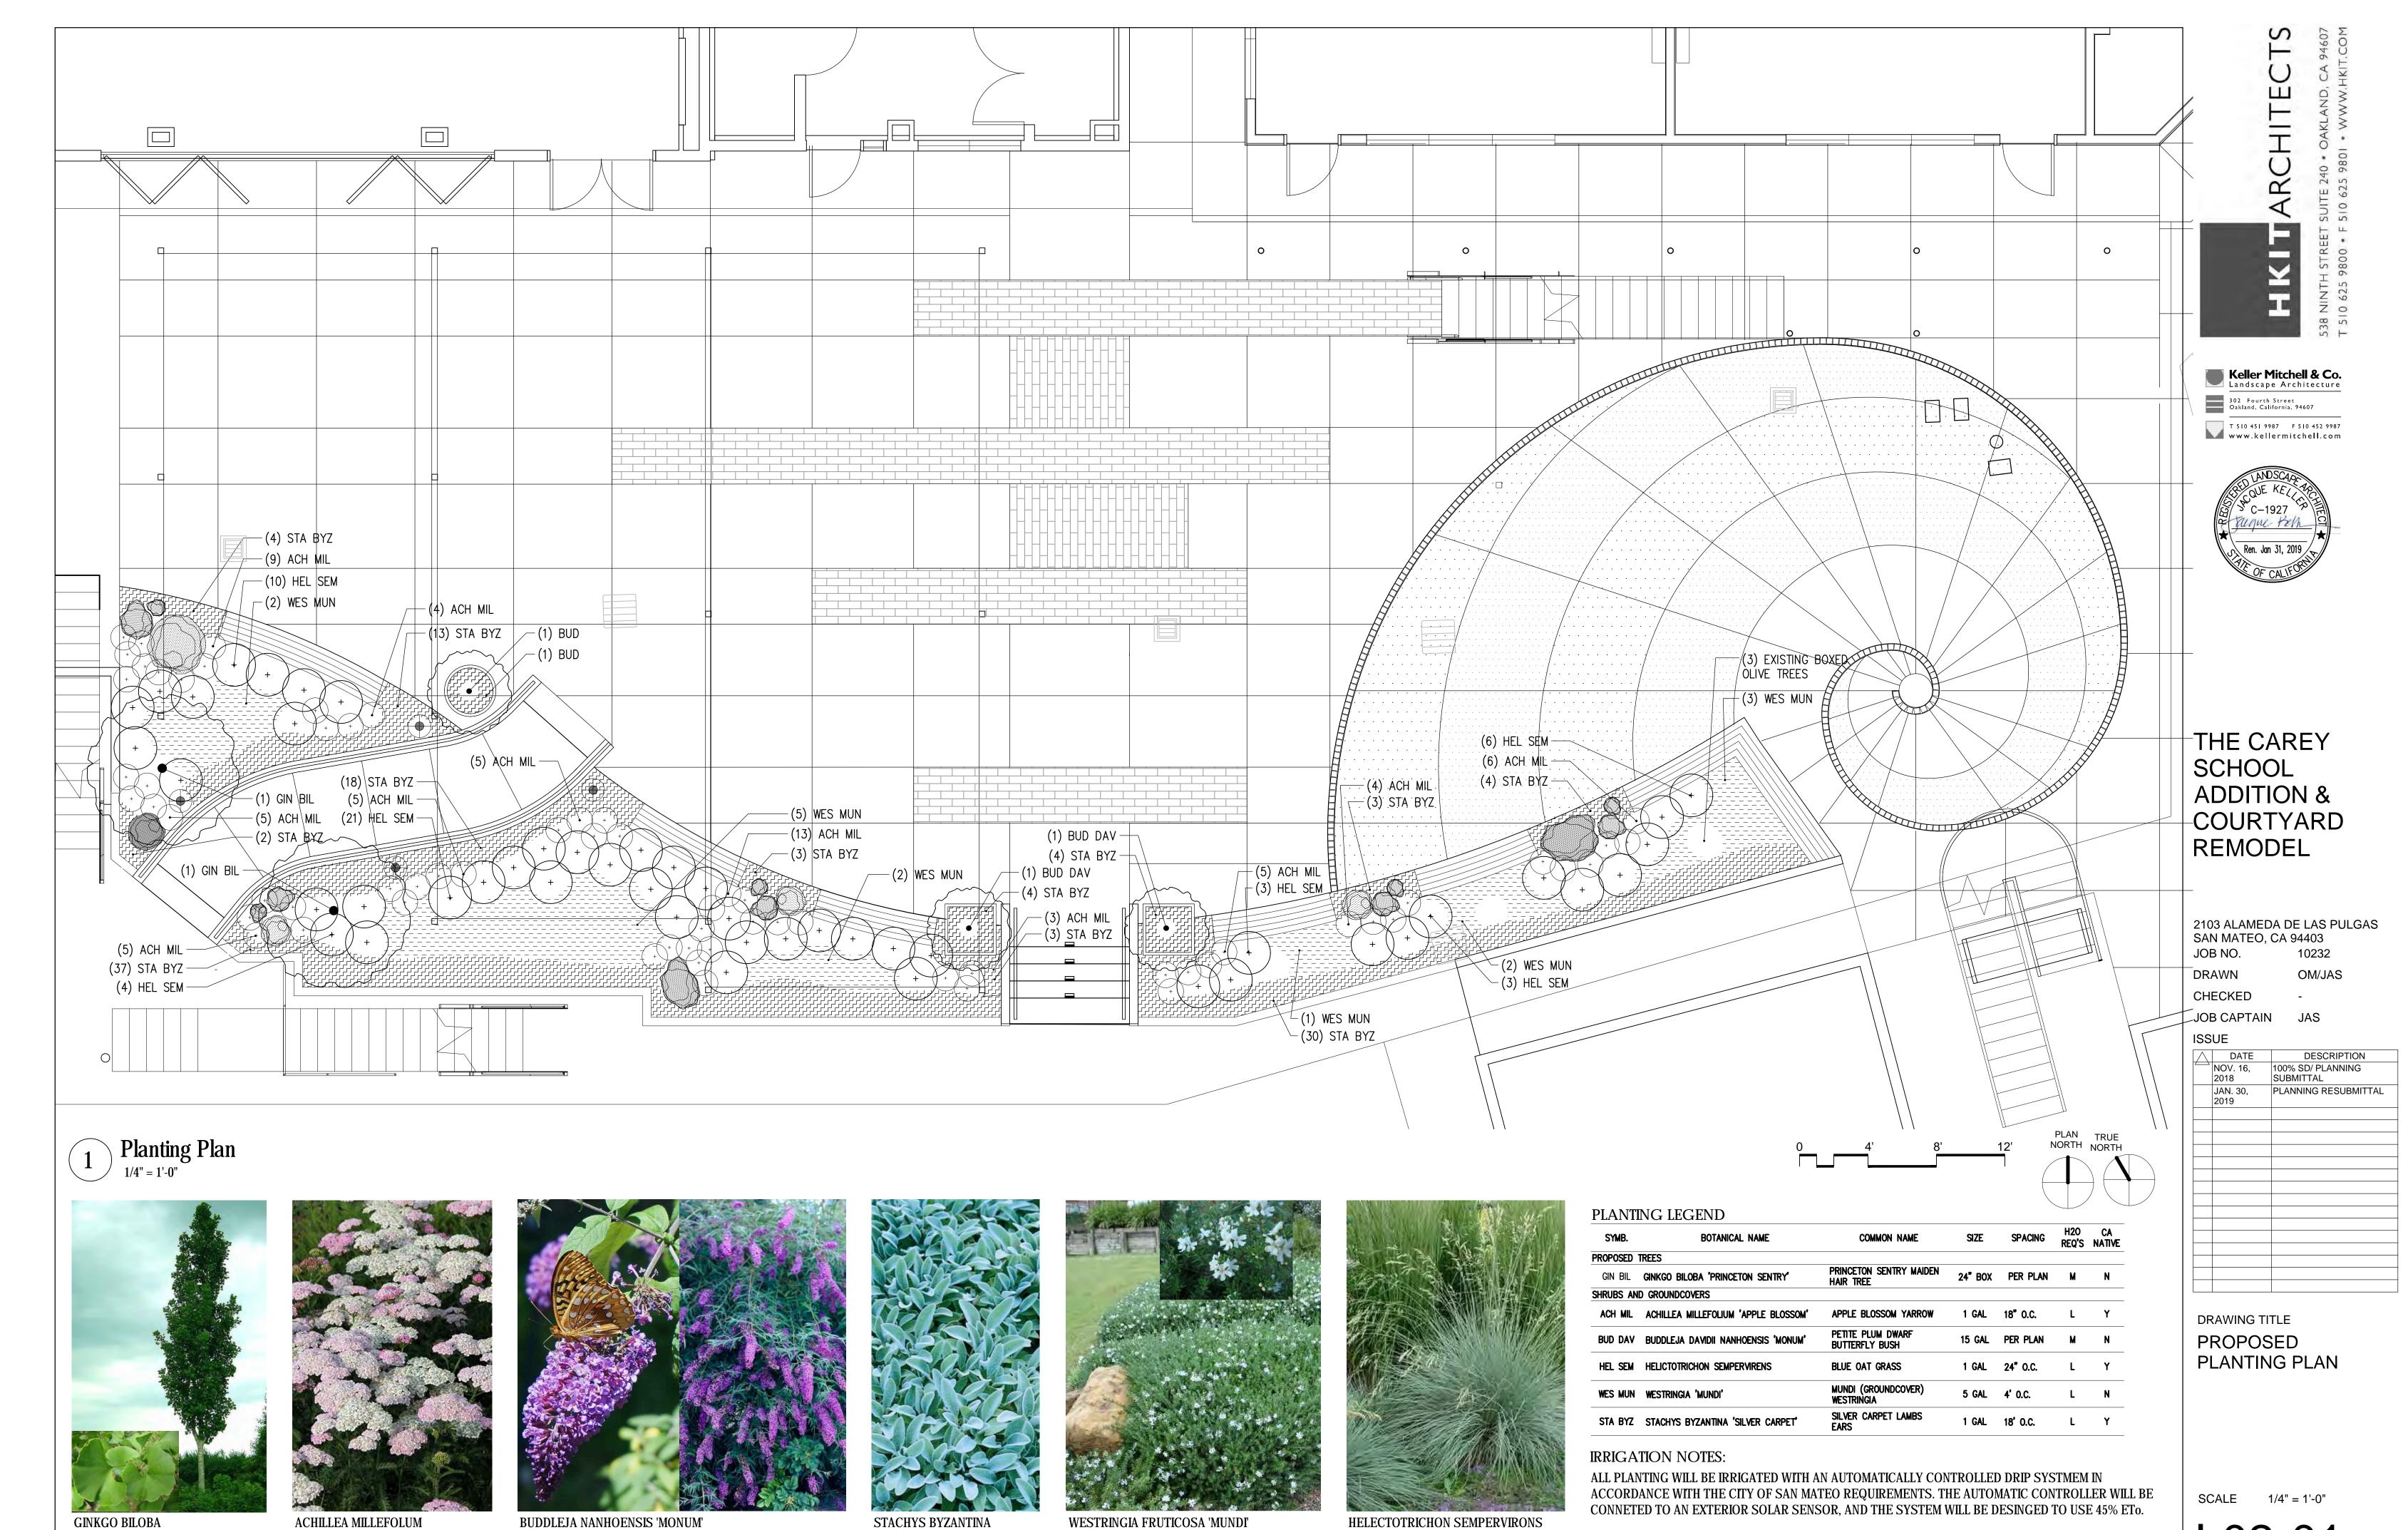

HELECTOTRICHON SEMPERVIRONS

BLUE OAT GRASS

GINKGO BILOBA

'PRINCETON SENTRY'

BUDDLEJA NANHOENSIS 'MONUM'

DWARF BUTTERFLY BUSH

'APPLE BLOSSOM' YARROW

STACHYS BYZANTINA

'SILVER CARPET' LAMBS EARS

Pebble 641

COLORED CONCRETE PAVING (TYPE 1)

Cobblestone 860

COLORED CONCRETE PAVING (TYPE 1)



GRANITE COBBLE BANDING



CONCRETE PAVER (TYPE A) FRENCH GRAY



CONCRETE PAVER (TYPE B) ADOBE TAUPE




TRELLIS SHADE FABRIC



CONCRETE BENCHES WITH WOOD SEATS



CLASS ROOM TILE IN FACE OF BENCHES

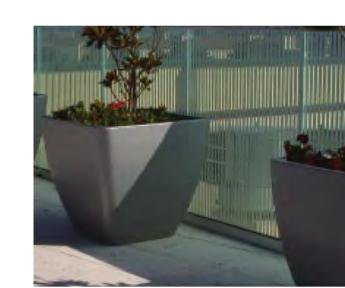

SQUARE PLANTER POT



ROUND PLANTER POT



BOULDERS IN PLANTING




CONCRETE TABLE AT MAKERS SPACE AREA



BOLLARD PATH LIGHT



RECESSED WALL (STEP) LIGHT

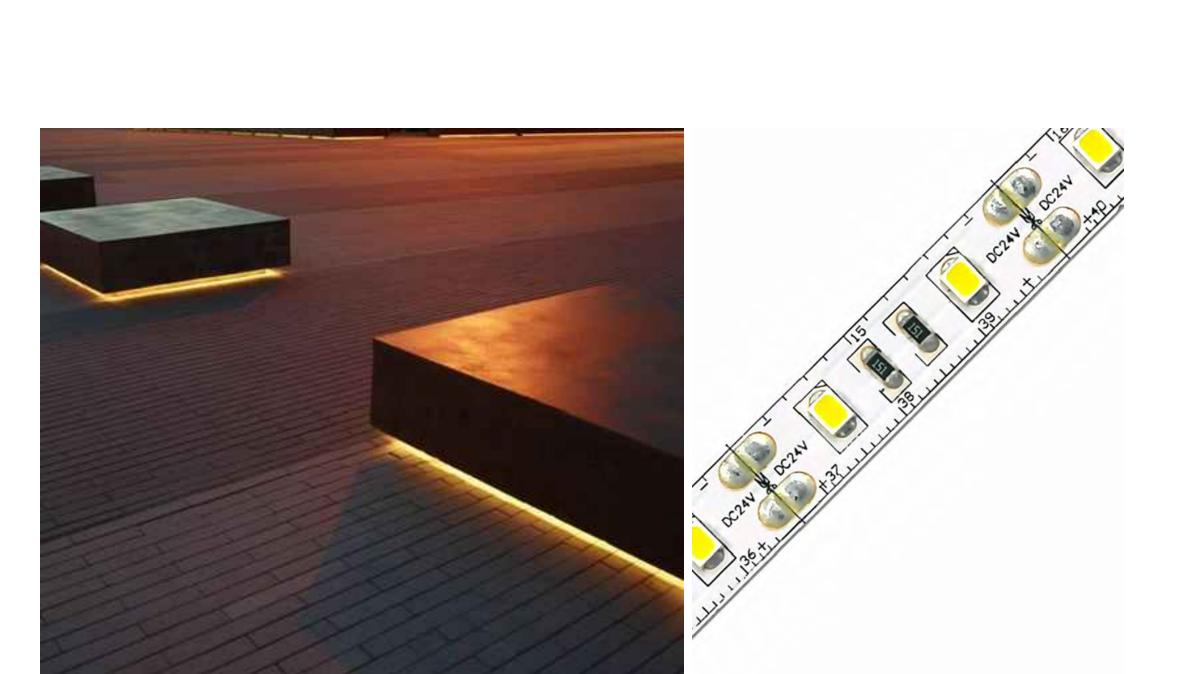

LINEAR BENCH LIGHTING



Keller Mitchell & Co.

Landscape Architecture

Oakland, California, 94607

T 510 451 9987 F 510 452 9987
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JOB CAPTAIN JAS

ISSUE

\wedge	DATE	DESCRIPTION
	NOV. 16, 2018	100% SD/ PLANNING SUBMITTAL
	JAN. 30, 2019	PLANNING RESUBMITTAL

PROPOSED LANDSCAPE MATERIALS IMAGES

SCALE N/A

